


# NEW TEMPLE BUILDING FOR ST. NICHOLAS ORTHODOX CHURCH

9100 Youree Dr, Shreveport, LA 71115

Project Status

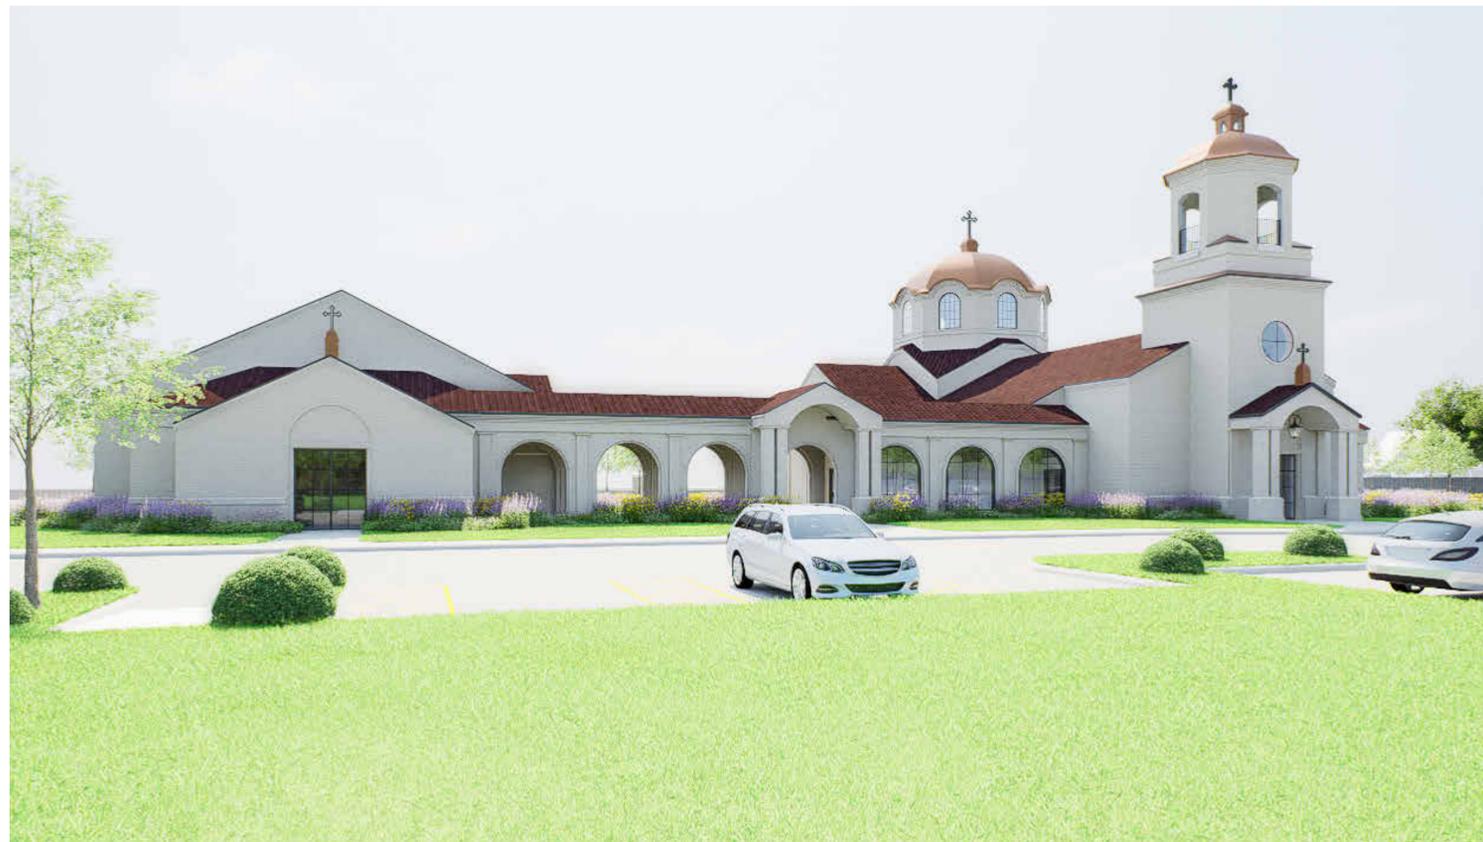

RENDERING FOR ILLUSTRATIVE PURPOSES ONLY.

Date:

10/31/2025

Project Number:

2505

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# ABBREVIATIONS

#	Pound OR Number	HOR	Horizontal	RCCP	Reinforced Concrete Culvert Pipe
@	At Spacing Of	HP	High Point	RCC	Reinforced Concrete Pipe
B.M.	Bench Mark	HR	Handrail	RD	Roof Drain
⬆	Center Line	HRL	Handrail	RDC	Reducer
⬆	Access Panel	HT	Height	REBAR	Reinforcing Steel Bars
⊙	Diameter, Round	HVAC	Heating, Ventilating, and AC	REP	Repair
AB	Anchorbolt	ID	Inside Diameter	REPL	Replace
AC	Acoustic Ceiling Tile	IGL	Insulating Glass	REQ	Require
AD	Area Drain	ILO	In Lieu Of	REQD	Required
ADJ	Adjacent	INCL	Include(ed), (ing)	RESIL	Resilient
ADJT	Adjustable	INSUL	Insulated, Insulation	RFI	Request for Information
AF	Above Finished Floor	INT	Interior	RFP	Request for Proposal
AGG	Aggregate	INV	Invert	RM	Room
AL	Aluminum	IRGWB	Impact Res. Gyp. Wall Board	ROW	Right of Way
ALN	Align	IT	Joist, Joint	RST	Reinforcing Steel
ALT	Alternate	JT	Joist, Joint	RT	Right
ANC	Anchor, Anchorage	KIT	Kitchen	RV	Relief Valve
ANOD	Anodized	KPL	Kickplate	RW	Roadway
AP	Access Panel	L	Length	RWL	Rain Water Leader
ARCH	Architect, Architectural	LAD	Ladder	RWR	Recessed Waste Receptacle
ASPH	Asphalt	LAM	Laminated(ed)	SIM	Similar
AWN	Awning	LAV	Lavatory	SSTL	Stainless Steel
BD	Board	LGB	Lag Bolt	SEP	Separate
BEL	Below	LG	Laminated Glass	SEP TNK	Septic Tank
BET	Between	LH	Left Hand	SF	Square Foot (Feet)
BKR	Backer	LL	Live Load	SJ	Scored Joint
BLDG	Building	LO	Low	SLV	Sleeve
BLKG	Blocking	LOC	Locate	SOV	Shut Off Valve
BM	Beam	LT	Light	SP	Standpipe, Sump Pit
BO	By Owner	LTL	Light	SP EL	Spot Elevation
BOT	Bottom	LVR	Lower	SPEC	Specified, Specification
BPL	Beating Plate	MAX	Maximum	SPK	Speaker
BRKT	Bracket	MECH	Mechanical	SPR	Sprinkler
BRG	Bearing	MEMBR	Membrane	SPLY	Supply
BS	Both Sides	MIN	Minimum	SPR	Sprinkler Line
BSMT	Basement	MO	Masonry Opening	SQ	Square
BYND	Beyond	MRGWB	Moisture-Res. Gyp. Wall Bd.	SQ IN	Square Inch
CAB	Cabinet	MTL	Metal	SQ YD	Square Yard
CB	Catch Basin	NAT	Natural	SR	Steam Return
CHAM	Chamfer	NIC	Not In Contract	SS	Sanitary Sewer, Storm Sewer
CHNL	Channel	NO	Number	SSP	Stainless Steel Pipe
CI	Cast Iron	NOM	Nominal	ST	Street
CIRC	Circumference	NTS	Not To Scale	ST W	Storm Water
CIP	Cast In Place	OA	Overall	STA	Station
CJ	Control Joint	OC	On Center	STC	Sound Transmission Coefficient
CL	Clear	OD	Outside Diameter	STD	Standard
CLR	Clear	OH	Opposite Hand	STIR	Stirrup
CLS	Closure	OH	Opposite Hand	STL	Steel
CMU	Concrete Masonry Unit	OND	Ornamental	STM	Steam
CNTR	Counter	OZ	Ounce	STRUCT	Structure, Structural
COL	Column	PA	Pipe Anchor	SURF	Surface
COMPR	Compressible	PAR	Parallel	SURV	Survey
CONC	Concrete	PAT	Pattern	SW	Sidewalk
CONN	Connection	PB	Pull box	SWG	Sewer
CONST	Construction	PC	Point of Curve	SYM	Symbol
CONT	Continuous	PCCA	Precast Concrete	T&G	Tongue And Groove
CONTR	Contract, Contractor	PCCP	Concrete Pavement	T&M	Time and Materials
CORR	Corrugated, Corridor	PCT	Percent	T/D	Telephone/Data
CT	Carpet	PED	Pedestal	TBM	Temporary Benchmark
CT	Ceramic Tile	PERF	Perforate	TB-XX	Test Boring-xx (TB-01)
CTYD	Courtyard	PERM	Permanent	TC	Traffic Control Plan
DBL	Double	PERP	Perpendicular	TCA	Trench Drain
DEMO	Demolish, Demolition	PH	Pressure Gage or Profile Gage	TE	Top Elevation
DIA	Diameter	PHOTO	Photograph	TEL	Telephone
DIAG	Diagonal	PHWR	Primary Hot Water Return	TEMP	Temporary
DM(S)	Dimension(s)	PHWS	Primary Hot Water Supply	THK	Thickness
DN	Down	PI	Point of Intersection	TLT	Toilet
DPR	Damper	PIV	Post Indicator Valve	TMH	Top of Manhole
DR	Door	PK GAR	Parking Garage	TN	True North
DS	Downspout	PK LOT	Parking Lot	TNL	Tunnel
DSL	Detail	PL	Property Line	TO	Top of
DWG	Drawing	PLAS	Plastic Plaster	TO FDN	Top of Foundation
DWR	Drawer	PLUMB	Plumbing	TO S	Top of Slab
EA	Expansion Bolt	PLYD	Plywood	TOB	Top of Beam
EJ	Each Face	PMPSCT	Pump Suction	TOC	Top of Concrete, Top of Curb
EJ	Expansion Joint	PN	Part Number	TOC FTG	Top of Concrete Footing
EL	Elevation	PNEU	Pneumatic	TOC WALL	Top of Concrete Wall
ELEC	Electrical	PO	Paint, Painted	TOF	Top of Footing
ELEV	Elevator, Elevation	POLY	Polyethylene (Plastic)	TOP	Top of Pavement
EP	Electrical Panelboard	PORT	Portable	TOPO	Topography
EPDM	Ethylene Propylene Diene M-Class	POTW	Potable Water	TOS	Top of Slab
EPX	Extruded Polystyrene	POW LN	Power Line	TP	Telephone Pole
ESMNT	Easement	PP	Polypropylene (Plastic)	TPD	Toilet Paper Dispenser
EST	Estimate	PR	Pumped Return	TR	Top of Rim
EQ	Equal	PRCST	Precast	TWR	Treated Water Return
EXIST	Existing	PREFMD	Preformed	TWS	Treated Water Supply
EXH	Exhaust	PRELIM	Preliminary	TY	Typical
EXT	Exterior	PREP	Preparation	UNP	Unpaved Road
FAS	Fasten, Fastener	PREV	Previous	UNPV RD	Unpaved Road
FD	Floor Drain, Fire Dept.	PRKQ	Parking	UP	Utility Pole
FE	Fire Extinguisher	PROJ	Project	UPS	Uninterruptible Power Supply
FEC	Fire Extinguisher Cabinet	PROP	Property	UTIL	Utility
FFE	Finished Floor Elevation	PRV	Pressure Regulator Valve or Pressure Relief Valve	VAR	Varies
FG	Floor Glass	PS CONC	Prestressed Concrete	VB	Valve Box
FG	Fiberglass	PSI	Pounds Per Square Inch	VC	Vertical Curve
FIN	Finish(ed)(ing)	PSL	Pipe Sleeve	VCO	Vacuum Cleaner Outlet
FIXT	Fixture	PT	Pressure Treated	VCT	Verifired Clay Tile, Vinyl Comp Tile
FL	Flow Line	PT CONC	Post-Tensioned Concrete	VERT	Vertical
FLG	Flashing	PTRV	Pressure Temperature Relief Valve	VIC	Vicinity
FLR	Floor	PV	Paved	VID	Video
FLX	Flexible	PV RD	Paved Road	VIF	Verify In Field
FM	Filled Metal	PVC	Polyvinyl Chloride (Plastic)	VOL	Volume
FND	Foundation	QT	Quarry Tile	VP	Vision Panel
FO	Face Of	QTR	Quarter	W	With
FR	Frame(d)(ing)	QTY	Quantity	W/O	Without
FRT	Fire-Retardant	QUAD	Quadrant	W	Waste, West, or Wide
FTG	Footing	QUAL	Quality	WO	Wood
FUR	Furred(d)(ing)	R	Radius or Range	WI	Wrought Iron
GA	Gauge	RAD	Radian	WL	Water Line
GALV	Galvanized	RAD	Radian	WLD	Welded
GB	Grab Bar(s)	RC	Reinforced Concrete	WM	Water Meter, Wire Mesh
GD	Grade, Grading	RCB	Reinforced Concrete Box	WM	Water Meter
GL	Glass, Glazing	RCP	Reflected Ceiling Plan	WO	Work Order
GWB	Gypsum Wall Board	RD	Roof Drain	WP	Water Pump
HC	Hollow Core			WT	Water Table
HCAP	Handicap			WT EL	Water Elevation
HDR	Header			WTR	Water
HDW	Hardware			WW	Waste Water
HM	Hollow Metal			WW	Warm White, Wireway
				XFMR	Transformer

# GENERAL NOTES

- THE STRUCTURAL, MECHANICAL AND ELECTRICAL DRAWINGS ARE SUPPLEMENTARY TO THE ARCHITECTURAL DRAWINGS. IT SHALL BE THE RESPONSIBILITY OF THE CONTRACTOR TO CHECK WITH THE ARCHITECTURAL DRAWINGS BEFORE THE INSTALLATION OF STRUCTURAL, MECHANICAL AND ELECTRICAL WORK. SHOULD THERE BE A DISCREPANCY BETWEEN THE ARCHITECTURAL DRAWINGS AND THE CONSULTING ENGINEERS DRAWINGS, SHALL BE BROUGHT TO THE ARCHITECTS ATTENTION FOR CLARIFICATION PRIOR TO INSTALLATION OF SAID WORK. ANY WORK INSTALLED IN CONFLICT WITH THE ARCHITECTURAL DRAWINGS SHALL BE CORRECTED BY THE CONTRACTOR AT HIS EXPENSE AND AT NO ADDITIONAL EXPENSE TO THE OWNER OR ARCHITECT.
- CONTRACTOR SHALL VERIFY ALL CONDITIONS AND DIMENSIONS AT JOB SITE PRIOR TO BIDDING AND START OF CONSTRUCTION. IF DISCREPANCIES ARE FOUND, THE ARCHITECT SHALL BE NOTED FOR CLARIFICATION BEFORE COMMENCING WORK.
- ALL SYMBOLS AND ABBREVIATIONS USED ON THE DRAWINGS ARE TO BE CONSTRUCTION STANDARDS. IF THE CONTRACTOR HAS QUESTIONS REGARDING SAME, OR THEIR EXACT MEANING, THE ARCHITECT SHALL BE NOTIFIED FOR CLARIFICATION.
- ALL WORK SHALL CONFORM TO THE REQUIREMENTS OF THE MOST CURRENT EDITION OF THE INTERNATIONAL BUILDING CODE, THE MOST CURRENT ADOPTED VERSION NFPA 101 LIFE SAFETY CODE, AND ALL OTHER GOVERNING AUTHORITIES HAVING JURISDICTION.
- CONTRACTOR SHALL SUBMIT SHOP DRAWINGS AND STRUCTURAL CALCULATIONS FOR WINDOW WALLS AND ENTRANCES, SHOWING DETAILED ATTACHMENT AND IMPOSED LOADS TO STRUCTURAL MEMBERS.
- ALL DIMENSIONS ARE TO FACE OF CONCRETE, COLUMN GRID LINES, FACE OF CONCRETE BLOCK WALLS AND FACE OF STUDS UNLESS OTHERWISE NOTED.
- OFFSET STUDS WHERE REQUIRED SO THAT FINISH WALL SURFACE WILL BE FLUSH.
- FINISH FLOOR ELEVATIONS ARE TO TOP OF CONCRETE, UNLESS OTHERWISE NOTED.
- CEILING HEIGHT DIMENSIONS ARE TO FINISHED SURFACES.
- GYPSUM BOARDS SHALL EXTEND 6" ABOVE CEILING AT ALL COLUMN CORES AND WALLS, UNLESS NOTED.
- INSTALL METAL CORNER BEADS AT ALL EXPOSED WALLBOARD EDGE. INSTALL CASING BEADS WHEREVER WALLBOARD, PLASTER, ETC. ABUTS A DISSIMILAR FINISH MATERIAL AND PROVIDE SEALANT AS REQUIRED.
- EXTEND PERIMETER WALLS OF CORE TO STRUCTURE ABOVE AND INSULATE.
- MINIMUM HEADROOM CLEARANCE AT STAIRS SHALL BE 7'-0" VERTICALLY FROM THE PLANE TANGENT TO THE TREAD NOSING. (FUTURE)
- PLENUM SPACES SHALL BE AIRTIGHT AND SEALED.
- CONTRACTOR SHALL VERIFY SIZE AND LOCATIONS OF ALL MECHANICAL EQUIPMENT PADS AND BASES AS WELL AS POWER AND WATER OR DRAIN INSTALLATIONS WITH EQUIPMENT MANUFACTURER'S BEFORE PROCEEDING WITH THE WORK. CHANGES TO ACCOMMODATE FIELD CONDITIONS OR SUBSTITUTIONS SHALL BE MADE WITHOUT ADDITIONAL CHARGE TO OWNER.
- DUCTS PENETRATING STUD WALLS OR SHAFT WALLS BE PROVIDED WITH NECESSARY FRAMES, BRACING AND SEALANT AROUND THE OPENING.
- CONTRACTOR SHALL PROVIDE AND INSTALL ALL STIFFENERS, BRACING, BACK-UP PLATES AND SUPPORTING BRACKETS REQUIRED FOR THE INSTALLATION OF ALL WALL MOUNTED OR SUSPENDED MECHANICAL, ELECTRICAL OR MISCELLANEOUS EQUIPMENT.
- CONTACT BETWEEN DISSIMILAR METAL SHALL BE PROTECTED. SEE SPECIFICATIONS.
- PROVIDE PORTABLE FIRE EXTINGUISHER WITH A RATING OF NOT LESS THAN 2-A WITHIN SEVENTY FIVE (75) FEET TRAVEL DISTANCE TO ALL PORTIONS OF THE BUILDING ON EACH FLOOR, OR AS REQUIRED BY THE FIRE DEPARTMENT FIELD INSPECTOR. FIRE EXTINGUISHER RATING TO BE NOT LESS THAN 20-B-C IN ALL MECHANICAL AND ELECTRICAL ROOMS.
- EMERGENCY LIGHTING SHALL BE PROVIDED GIVING A VALUE OF ONE FOOT CANDLE MINIMUM AT FLOOR LEVEL IN ALL EXIT CORRIDORS AND STAIR SHAFTS.
- FIRE DAMPERS OR DOORS SHALL BE PROVIDED WHERE AIR DUCTS PENETRATE FIRE RATED WALL OR CEILING.
- ALL WOOD TRIMS, SPACER, FILLER ETC., THROUGHOUT JOB SHALL BE FIRE TREATED.
- ROOFING SYSTEM SHALL BEAR U.L. LISTING AS A CLASS "A" SYSTEM. ALL MANUFACTURED MATERIALS USED SHALL BEAR THE APPROPRIATE U.L. LABEL.
- INTERIOR WALL AND CEILING FINISHES FOR EXIT CORRIDORS SHALL NOT EXCEED AN END POINT FLAME SPREAD RATING OF 75, STAIRWELL 25.
- ALL EXIT LIGHTING AND SIGNS TO HAVE 6 INCH HIGH LETTERS IN ACCORDANCE WITH LOCAL CODES. PROVIDE LOW LEVEL EXIT SIGNS PER CODE REQUIREMENTS.
- TOILET ROOMS SHALL BE EQUIPPED WITH A MECHANICAL SYSTEM OF VENTILATION PROVIDING A MINIMUM OF FOUR AIR CHANGES PER HOUR AS PER CODE. REFER TO MECHANICAL DRAWINGS AND SPECIFICATIONS.
- ALL LEGAL EXIT DOORS SHALL BE OPENABLE FROM THE INSIDE WITHOUT THE USE OF A KEY OR ANY SPECIAL KNOWLEDGE OR EFFORT AND SHALL SWING IN THE DIRECTION OF EGRESS. SPECIAL LOCKING DEVICES SHALL BE OF AN APPROVED TYPE.
- ALL RATED DOORS AND PENTHOUSE DOORS SHALL HAVE GASKET AT HEAD AND JAMB.
- CONTRACTOR SHALL VERIFY ALL CONCRETE AND MASONRY OPENINGS IN THE FIELD PRIOR TO THE FABRICATION OF DOORS AND FRAMES.
- AIR LEAKAGE AT EXTERIOR DOORS SHALL BE LIMITED BY THE FOLLOWING:
  - ALL DOORS SHALL BE PROVIDED WITH A SEAL OR ASTRAGAL.
  - DOORS MOUNTED ON EITHER THE INSIDE OR OUTSIDE OF AN EXTERIOR WALL SHALL HAVE A MINIMUM OF ONE - INCH LAP AT EACH JAMB.
  - DOORS REQUIRING VERTICAL TRACK OR GUIDES SHALL USE A CONTINUOUS MOUNTING ANGLE, SEALED IN ACCORDANCE WITH "G" LISTED HERE.
  - DOORS MOUNTED BETWEEN THE JAMBS SHALL HAVE A CONTINUOUS SEAL OR BAFFLE AT EACH JAMB.
  - MEETING RAILS OR SECTIONS DOORS AND MEETING STILES OR RAILS OF BIPARTING DOORS SHALL BE PROVIDED WITH A SEAL, ASTRAGAL OR BAFFLE.
  - SWINGING AND REVOLVING DOORS SHALL BE WEATHER-STRIPPED AT THE HEAD, SILL AND JAMB.
  - OPEN EXTERIOR JOINTS AROUND WINDOW AND DOOR FRAMES, BETWEEN WALL AND FOUNDATIONS, BETWEEN WALL AND ROOF, BETWEEN WALL PANELS, AT PENETRATIONS OF UTILITY SERVICES THROUGH WALLS, FLOORS AND ROOFS AND ALL OTHER OPENINGS THROUGH THE EXTERIOR ENVELOPE SHALL BE SEALED, CALKED, GASKETED, OR WEATHER-STRIPPED TO LIMIT AIR LEAKAGE.
  - ALL DOOR SIZES SHOWN ON DOOR OPENING SIZES. ALLOWANCE FOR THRESHOLDS ETC. SHALL BE TAKEN OFF DOOR. ALL DOORS AND FRAMES SHALL BE REINFORCED WHERE REQUIRED FOR CLOSERS, STOPS AND HARDWARE.

# BUILDING CLASSIFICATION: CODE INFORMATION: LOUISIANA

USE:	BUSINESS - OFFICE
OCCUPANCY CLASSIFICATION:	BUSINESS OCCUPANCY - GROUP B
TYPE OF CONSTRUCTION TABLE 503	TYPE II-B (IBC) ALLOWABLE HEIGHT: 3 STORIES ALLOWABLE AREA: 23,000
PROJECT SQUARE FOOTAGE	FIRST FLOOR - RENOVATION 0 S.F. FIRST FLOOR - NEW CONSTRUCTION 0 S.F. HEATED, 0 S.F. UNDER ROOF
AUTOMATIC SPRINKLER SYSTEM:	NOT SPRINKLED
ALLOWABLE AREA IBC 506.2:	TYPE II B BUSINESS, NOT SPRINKLED: 23,000 SQ.FT. ALLOWABLE
BUILDING ELEMENTS - FIRE RESISTANT REQUIREMENTS	RATING ASSEMBLY
FIRE WALLS	2 HR N/A
STRUCTURAL FRAME BEARING WALLS	0 HR N/A
EXTERIOR INTERIOR	0 HR N/A
NON-BEARING WALLS	EXTERIOR 1 HR <30' AS NOTED ON PLAN INTERIOR
FLOOR CONSTRUCTION	0 HR N/A
ROOF CONSTRUCTION	0 HR N/A

GOVERNING STATE AND LOCAL REGULATIONS

LOUISIANA STATE UNIFORM CONSTRUCTION CODE (LSUCC):

2021	INTERNATIONAL BUILDING CODE (IBC) (NOT INCLUDING CHAPTERS 1, 11, 27 AND 29)
2021	INTERNATIONAL MECHANICAL CODE (IMC)
2015	NFPA 1, 2015 EDITION (LOCAL FIRE CODE)
2021	INTERNATIONAL PLUMBING CODE (IPC)
2020	NATIONAL ELECTRIC CODE (NEC)
2021	INTERNATIONAL FUEL GAS CODE (IFGC)
2015	NFPA 101: LIFE SAFETY CODE
2010	ADA STANDARDS FOR ACCESSIBLE DESIGN GUIDELINES FOR DESIGN AND CONSTRUCTION OF HEALTHCARE FACILITIES-THE FACILITY GUIDELINES INSTITUTE (FGI)
2021	INTERNATIONAL EXISTING BUILDING CODE (IEBC)
2021	INTERNATIONAL ENERGY CONSERVATION CODE

# CODE TABLES:

TABLE 601

FIRE-RESISTANCE RATING REQUIREMENTS FOR BUILDING ELEMENTS (hours)

BUILDING ELEMENT	TYPE I		TYPE II		TYPE III		TYPE IV		TYPE V	
	A	B	A <sup>d</sup>	B	A <sup>d</sup>	B	HT	A <sup>d</sup>	B	
PRIMARY STRUCTURAL FRAME	3 <sup>a</sup>	2 <sup>a</sup>	1	0	1	0	HT	1	0	
BEARING WALLS EXTERIOR <sup>g</sup>	3 <sup>a</sup>	2 <sup>a</sup>	1	0	2	0	2	1/HT	1	
NONBEARING WALLS AND PARTITIONS EXTERIOR	SEE TABLE 602									
NONBEARING WALLS AND PARTITIONS INTERIOR	0	0	0	0	0	0	SEE SECT 602.4.6	0	0	
FLOOR CONSTRUCTION INCL. SUPPORTING BEAMS AND JOISTS	2	2	1	0	1	0	HT	1	0	
ROOF CONSTRUCTION INCL. SUPPORTING BEAMS AND JOISTS	1 1/2 <sup>b</sup>	1 <sup>b,c</sup>	1 <sup>b,c</sup>	0 <sup>c</sup>	1 <sup>b,c</sup>	0	HT	1 <sup>b,c</sup>	0	

- FOR SI: 1 FOOT=304.8mm
- ROOF SUPPORTS: FIRE-RESISTANCE RATINGS OF PRIMARY STRUCTURAL FRAME AND BEARING WALLS ARE PERMITTED TO BE REDUCED BY 1 HOUR WHERE SUPPORTING A ROOF ONLY.
  - EXCEPT IN GROUP F-1, H, M, AND S-1 OCCUPANCIES, FIRE PROTECTION OF STRUCTURAL MEMBERS SHALL NOT BE REQUIRED, INCLUDING PROTECTION OF ROOF FRAMING AND DECKING WHERE EVERY PART OF THE ROOF CONSTRUCTION IS 20 FEET OR MORE ABOVE ANY FLOOR IMMEDIATELY BELOW. FIRE RETARDANT-TREATED WOOD MEMBERS SHALL BE ALLOWED TO BE USED FOR SUCH UNPROTECTED MEMBERS IN ALL OCCUPANCIES. HEAVY TIMBER SHALL BE ALLOWED WHERE A 1 HOUR OR LESS FIRE RESISTANCE RATING IS REQUIRED.
  - AN APPROVED AUTOMATIC SPRINKLER SYSTEM IN ACCORDANCE WITH SECTION 903.3.1.1 SHALL BE ALLOWED TO BE SUBSTITUTED FOR 1 HOUR FIRE RESISTANCE RATED CONSTRUCTION PROVIDED SUCH SYSTEM IS NOT OTHERWISE REQUIRED BY OTHER PROVISIONS OF THE CODE OR USED FOR AN ALLOWABLE AREA INCREASE IN ACCORDANCE WITH SECTION 506.3 OR AN ALLOWABLE HEIGHT INCREASE IN ACCORDANCE WITH SECTION 504.2. THE 1 HOUR SUBSTITUTION FOR THE FIRE RESISTANCE OF EXTERIOR WALLS SHALL NOT BE PERMITTED.
  - NOT LESS THAN THE FIRE-RESISTANCE RATING REQUIRED BY OTHER SECTIONS OF THIS CODE.
  - NOT LESS THAN THE FIRE-RESISTANCE RATING BASED ON FIRE SEPARATION DISTANCE (SEE TABLE 602).
  - NOT LESS THAN THE FIRE-RESISTANCE RATING AS REFERENCED IN SECTION 704.10.

TABLE 705.5


FIRE-RESISTANCE RATING REQUIREMENTS FOR EXTERIOR WALLS BASED ON FIRE SEPARATION DISTANCE

FIRE SEPARATION DISTANCE = X (feet)	TYPE OF CONSTRUCTION	OCCUPANCY GROUP H <sup>e</sup>	OCCUPANCY GROUP F-1, M, S-1 <sup>f</sup>	OCCUPANCY GROUP A, B, E, F-2, I, R, S-2, U <sup>h</sup>
< 5 <sup>b</sup>	ALL	3	2	1
5 ≥ X < 10	IA	3	1	1
	OTHERS	2	1	1
10 ≥ X < 30	IA, IB, IVA, IVB	2	1	1 <sup>c</sup>
	IB, VB	1	0	0
	OTHERS	1	1	1 <sup>c</sup>
X ≥ 30	ALL	0	0	0

- FOR SI: 1 FOOT=304.8mm
- LOAD-BEARING EXTERIOR WALLS SHALL ALSO COMPLY WITH THE FIRE-RESISTANCE RATING REQUIREMENTS OF TABLE 601.
  - SEE SECTION 706.1.1 FOR PARTY WALLS.
  - OPEN PARKING GARAGES COMPLYING WITH SECTION 406 SHALL NOT BE REQUIRED TO HAVE A FIRE-RESISTANCE RATING.
  - THE FIRE-RESISTANCE RATING OF AN EXTERIOR WALL IS DETERMINED BASED UPON THE FIRE SEPARATION DISTANCE OF THE EXTERIOR WALL AND THE STORY IN WHICH THE WALL IS LOCATED.
  - FOR SPECIAL REQUIREMENTS FOR GROUP H OCCUPANCIES, SEE SECTION 415.6.
  - FOR SPECIAL REQUIREMENTS FOR GROUP S AIRCRAFT HANGARS, SEE SECTION 412.3.1.
  - WHERE TABLE 705.5 PERMITS NONBEARING EXTERIOR WALLS WITH UNLIMITED AREA OF UNPROTECTED OPENINGS, THE REQUIRED FIRE-RESISTANCE RATING FOR THE EXTERIOR WALLS IS 0 HOURS.
  - FOR A BUILDING CONTAINING ONLY A GROUP U OCCUPANCY PRIVATE GARAGE OR CARPORT, THE EXTERIOR WALL SHALL NOT BE REQUIRED TO HAVE A FIRE-RESISTANCE RATING WHERE THE FIRE SEPARATION DISTANCE IS 5 FEET (1523 MM) OR GREATER.
  - FOR A GROUP R-3 BUILDING OF TYPE II-B OR TYPE V-B CONSTRUCTION, THE EXTERIOR WALL SHALL NOT BE REQUIRED TO HAVE A FIRE-RESISTANCE RATING WHERE THE FIRE SEPARATION DISTANCE IS 5 FEET (1523 MM) OR GREATER.

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ARCHITECTURE + INTERIOR DESIGN  
533 TEXAS STREET, SUITE 1900 SHREVEPORT, LA 71101

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**NOT FOR CONSTRUCTION**

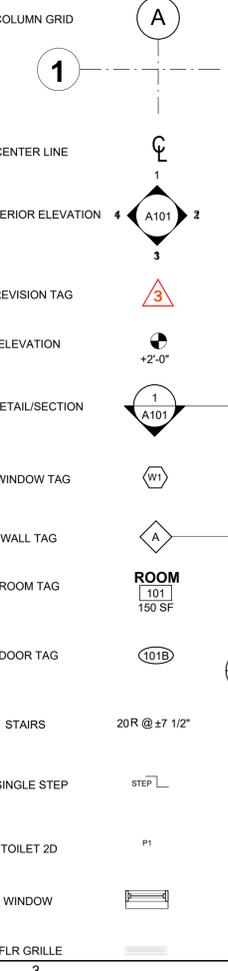NEW TEMPLE BUILDING FOR  
**ST. NICHOLAS ORTHODOX CHURCH**  
9100 Youree Dr., Shreveport, LA 71115

Date: 10/31/2025  
REVISION DATE

Drawn by: EBW  
Checked by: Checker  
Project #: 2505  
Sheet:

**G1.1**

PROJECT INFO

**PRELIMINARY NOT FOR CONSTRUCTION**

A


B

C

D

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### LIFE SAFETY PLAN NOTES:

- A. ALL REQUIRED EXITS SHALL REMAIN OPEN DURING THE DURATION OF THE PROJECT AND TO BE KEPT CLEAR OF EQUIPMENT, MATERIALS, DEBRIS ETC.
- B. ALL REQUIRED EXIT EGRESS WIDTHS SHALL NOT BE DECREASED DURING THE DURATION OF THE PROJECT AND TO BE KEPT CLEAR OF EQUIPMENT, MATERIALS, DEBRIS ETC.
- C. REQUIRED TRAVEL DISTANCE BETWEEN FIRE EXTINGUISHERS SHALL BE MAINTAINED AT ALL TIMES. THE CONTRACTOR SHALL PROVIDE TEMPORARY FIRE EXTINGUISHER WHICH ARE PROPERLY MARKED WHEN TRAVEL DISTANCE IS INTERRUPTED BY THE CONSTRUCTION PROCESS. THE CONTRACTOR SHALL BE RESPONSIBLE FOR MAINTAINING ANY EXISTING FIRE PROTECTION OR ALARM SYSTEM. THE CONTRACTOR SHALL NOTIFY THE OWNER AND LOCAL FIRE OFFICIAL IN WRITING IF ANY PART OF THE FIRE PROTECTION OR FIRE ALARM SYSTEM IS TO BE INTERRUPTED. THE CONTRACTOR SHALL BE RESPONSIBLE FOR PROPERLY MARKING ANY AND ALL TEMPORARY EXITS.
- F. THE CONTRACTOR SHALL BE RESPONSIBLE FOR MAINTAINING THE EMERGENCY EXITS SIGNAGE AND LIGHTING SYSTEM INCLUDING BUT NOT LIMITED TO TEMPORARY SIGNAGE AND LIGHTING AS REQUIRED BY CODE OR LOCAL BUILDING AND FIRE OFFICIALS.
- G. THE CONTRACTOR SHALL BE RESPONSIBLE FOR THE RESTORATION OF ANY RATED ASSEMBLY DISTURBED BY THE CONSTRUCTION PROCESS, TO ITS ORIGINAL INTEGRITY.
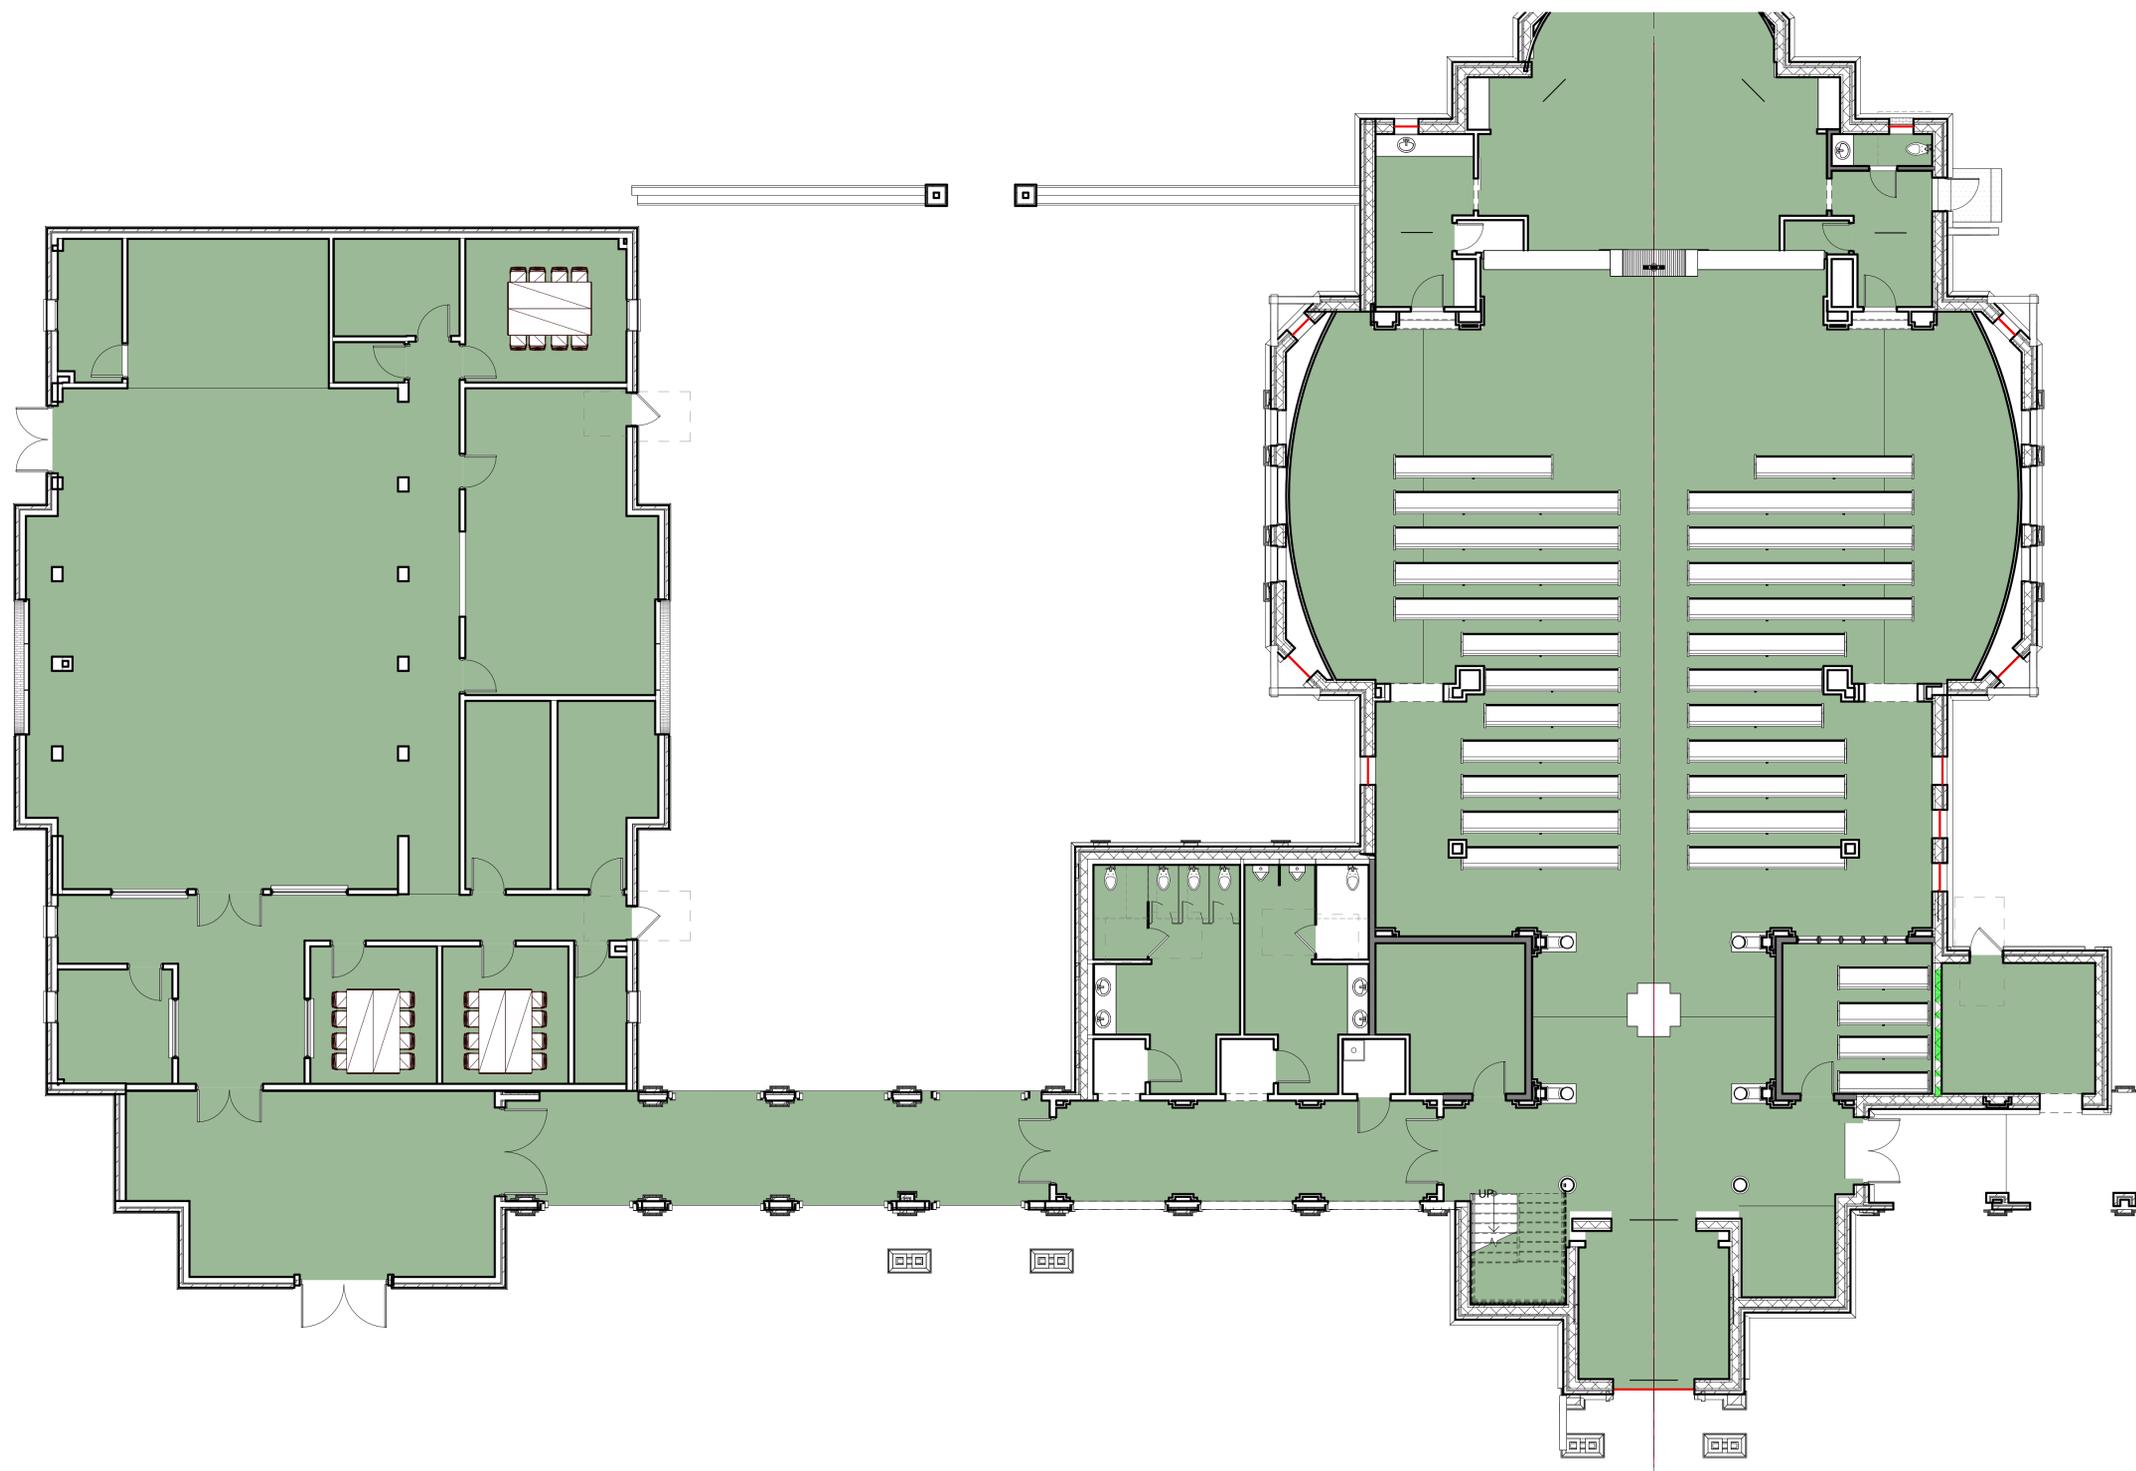
### LIFE SAFETY PLAN SYMBOLS:

- NOTE: SEE ELECTRICAL DRAWINGS FOR LOCATIONS OF FIRE ALARMS, FIRE ALARM PULL STATIONS, SMOKE DETECTORS, STROBES, AND EMERGENCY LIGHTING.
- EGRESS DIRECTION OF EXIT UNITS (INCHES)
  - EXIT SIGN/ EGRESS DIRECTION
  - EXIT INCHES PROVIDED
  - EXIT INCHES REQUIRED
  - FIRE EXTINGUISHER/FIRE EXTINGUISHER CABINET
  - FIRE ALARM PULL STATION
  - FIRE ALARM AUDIO/VISUAL SIGNAL DEVICE
  - FIRE ALARM AUDIO SIGNAL DEVICE
  - FIRE ALARM VISUAL SIGNAL DEVICE
  - TRAVEL DISTANCE INDICATION LINE

### WALL RATINGS LEGEND:

- NOTES:  
 A. RATED WALL DESIGNATIONS ARE DRAWN THROUGH OPENINGS TO INDICATE THAT THE WALL CONSTRUCTION ABOVE THE OPENING HAS THE SAME RATING AS THE CONSTRUCTION ON EITHER SIDE OF OPENING.  
 B. THE CONTRACTOR MUST SUBMIT DOCUMENTATION WHEN RATED WALL ASSEMBLY HAS BEEN TESTED AND APPROVED BY AGENCY OTHER THAN U.L.
- NON RATED SMOKE PARTITION - UL  
DOOR AND FRAME - NOT RATED  
DAMPERS - NOT REQUIRED  
PENETRATIONS/PERIMETER - SEALED
  - ONE HOUR FIRE BARRIER - UL  
DOOR AND FRAME - 45 MIN. RATING  
DAMPERS - FIRE - SEE MECH. CODE  
PENETRATIONS/PERIMETER - FIRE CAULKED  
EXTEND ENTIRE WALL CONSTRUCTION TO DECK ABOVE.
  - TWO HOUR FIRE BARRIER - UL  
DOOR AND FRAME - 90 MIN. RATING  
DAMPERS - FIRE - SEE MECH. CODE  
PENETRATIONS/PERIMETER - FIRE CAULKED  
EXTEND ENTIRE WALL CONSTRUCTION TO DECK ABOVE.
  - FIRE/SMOKE BARRIER  
DOOR AND FRAME - 20 MIN. RATING  
DAMPERS - SMOKE - SEE MECH. CODE  
PENETRATIONS/PERIMETER - FIRE CAULKED  
EXTEND ENTIRE WALL CONSTRUCTION TO DECK ABOVE (ONE HOUR WALL CONSTRUCTION)
  - ONE HOUR FIRE/SMOKE BARRIER  
DOOR AND FRAME - 45 MIN. RATING  
DAMPERS - FIRE AND SMOKE - SEE MECH. CODE  
PENETRATIONS/PERIMETER - FIRE CAULKED  
EXTEND ENTIRE WALL CONSTRUCTION TO DECK ABOVE.
  - TWO HOUR FIRE/SMOKE BARRIER  
DOOR AND FRAME - 90 MIN. RATING  
DAMPERS - FIRE AND SMOKE - SEE MECH. CODE  
PENETRATIONS/PERIMETER - FIRE CAULKED  
EXTEND ENTIRE WALL CONSTRUCTION TO DECK ABOVE.

## 1 LIFE SAFETY PLAN

SCALE: 1/8" = 1'-0"

**SOMDAL ASSOCIATES**  
ARCHITECTURE + INTERIOR DESIGN  
333 TEXAS STREET, SUITE 1900 SHREVEPORT, LA 71101

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NEW TEMPLE BUILDING FOR  
**ST. NICHOLAS ORTHODOX CHURCH**  
9100 Youree Dr, Shreveport, LA 71115


Date: 10/31/2025  
REVISION DATE

Drawn by: EBW  
Checked by: Checker  
Project #: 2505  
Sheet:

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LIFE SAFETY PLAN

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1 SITE PLAN  
SCALE: 1" = 30'-0"

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9100 Youree Dr, Shreveport, LA 71115
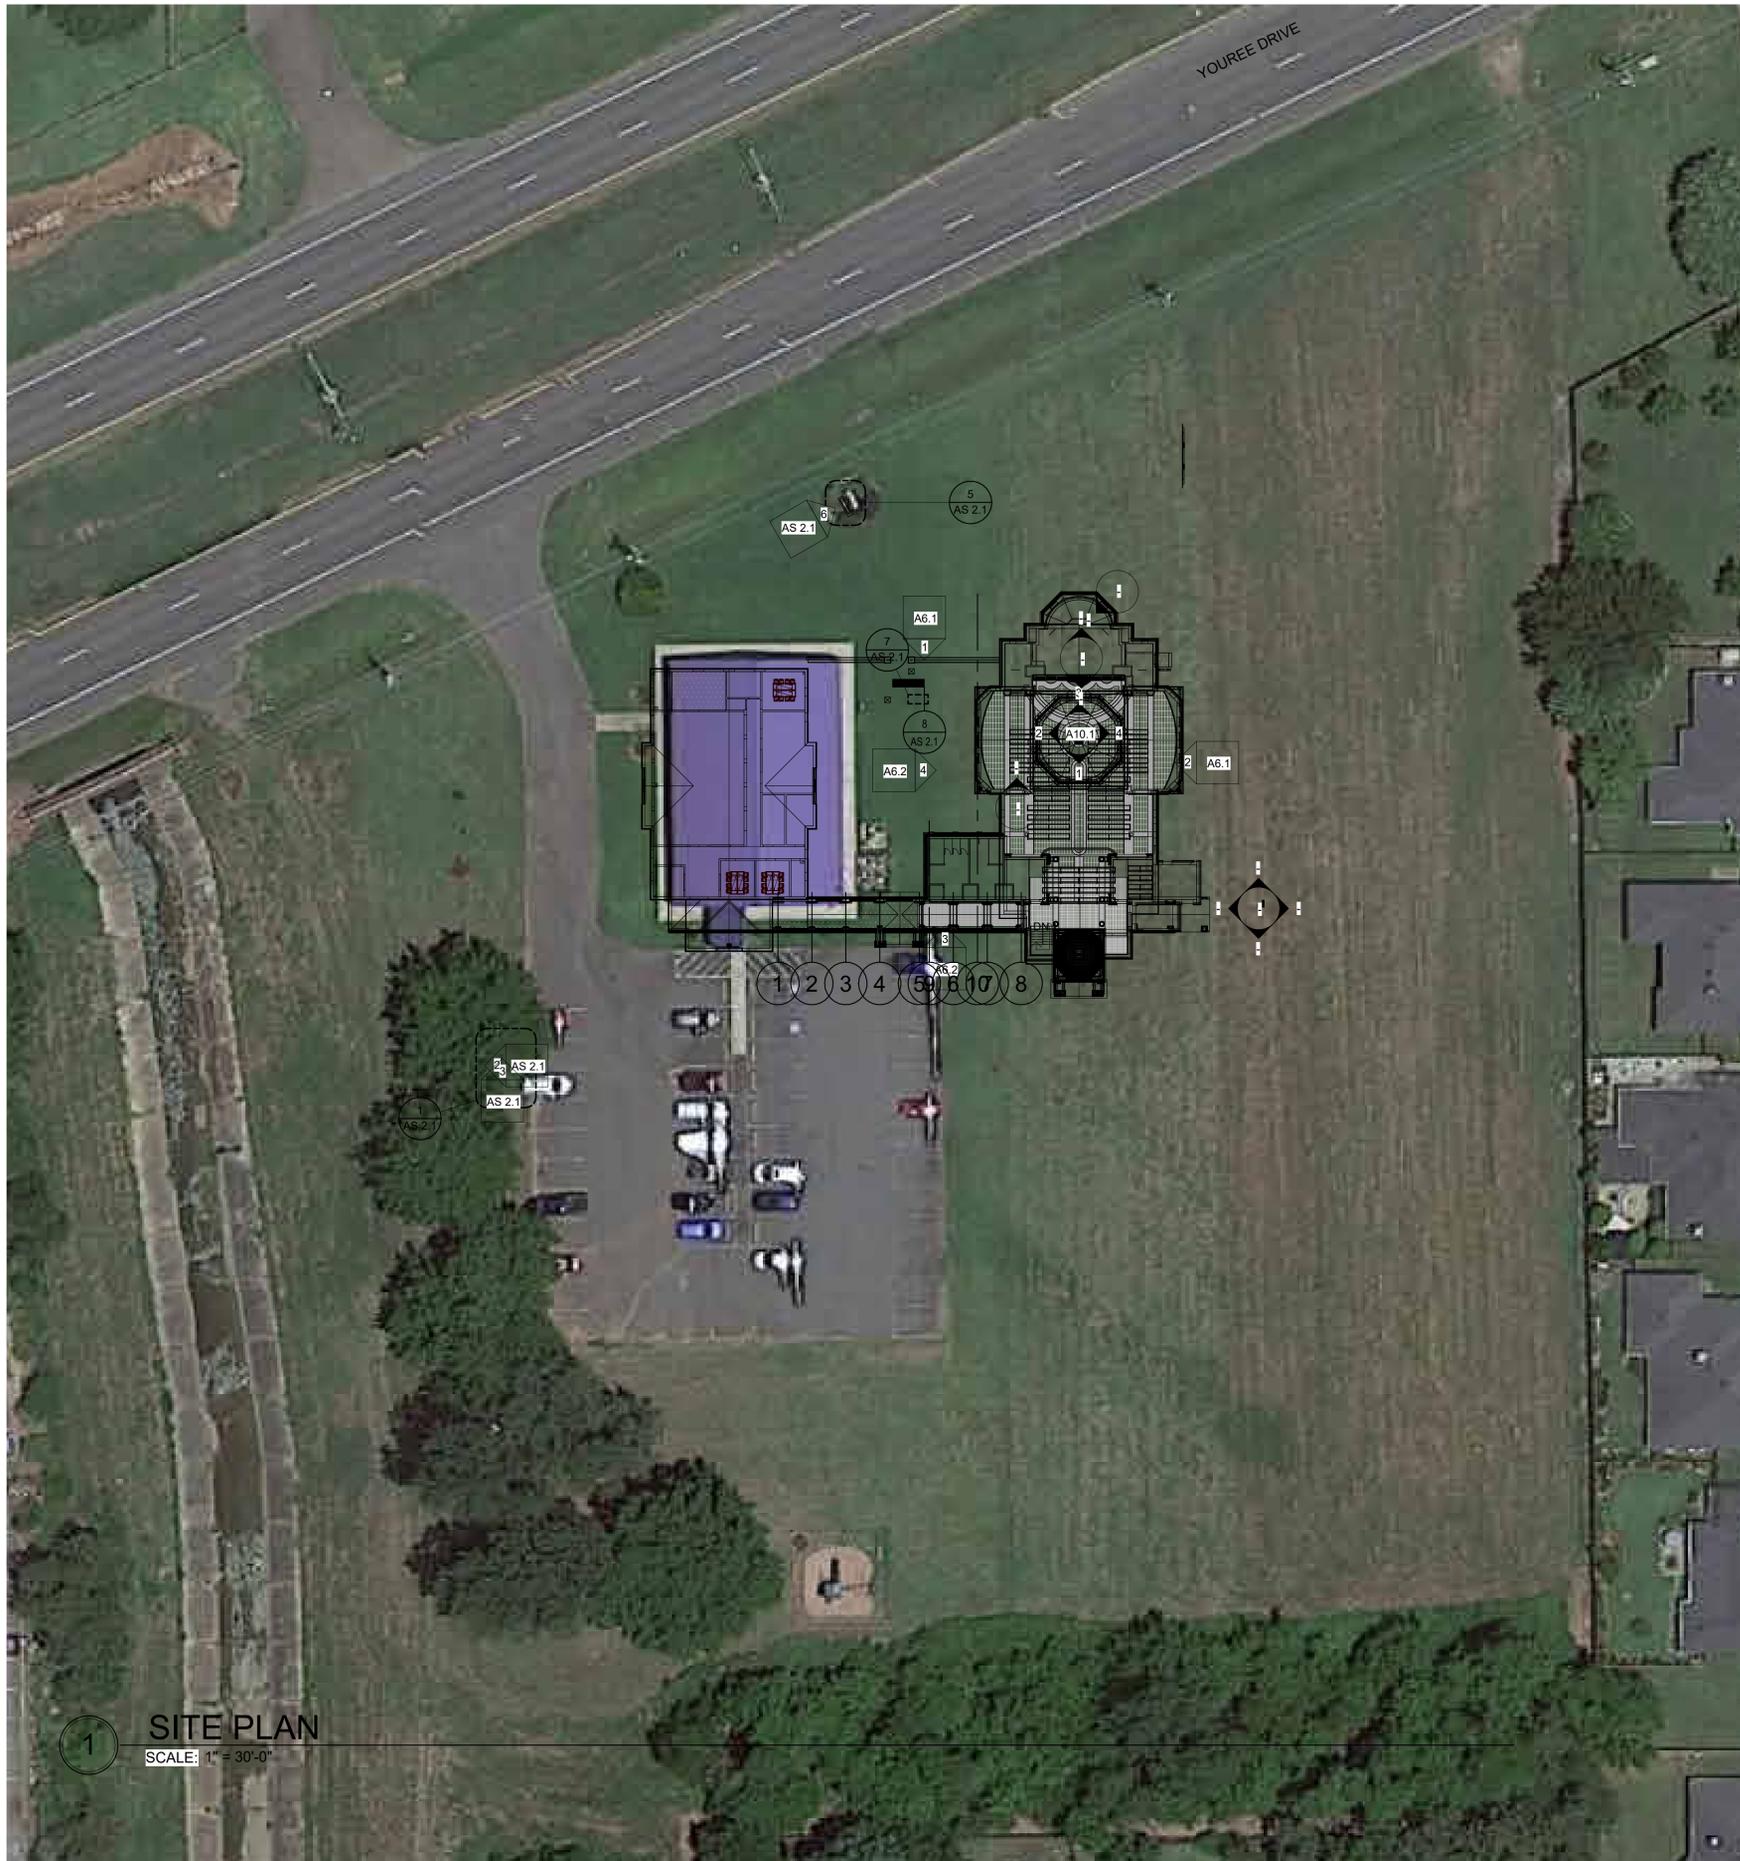
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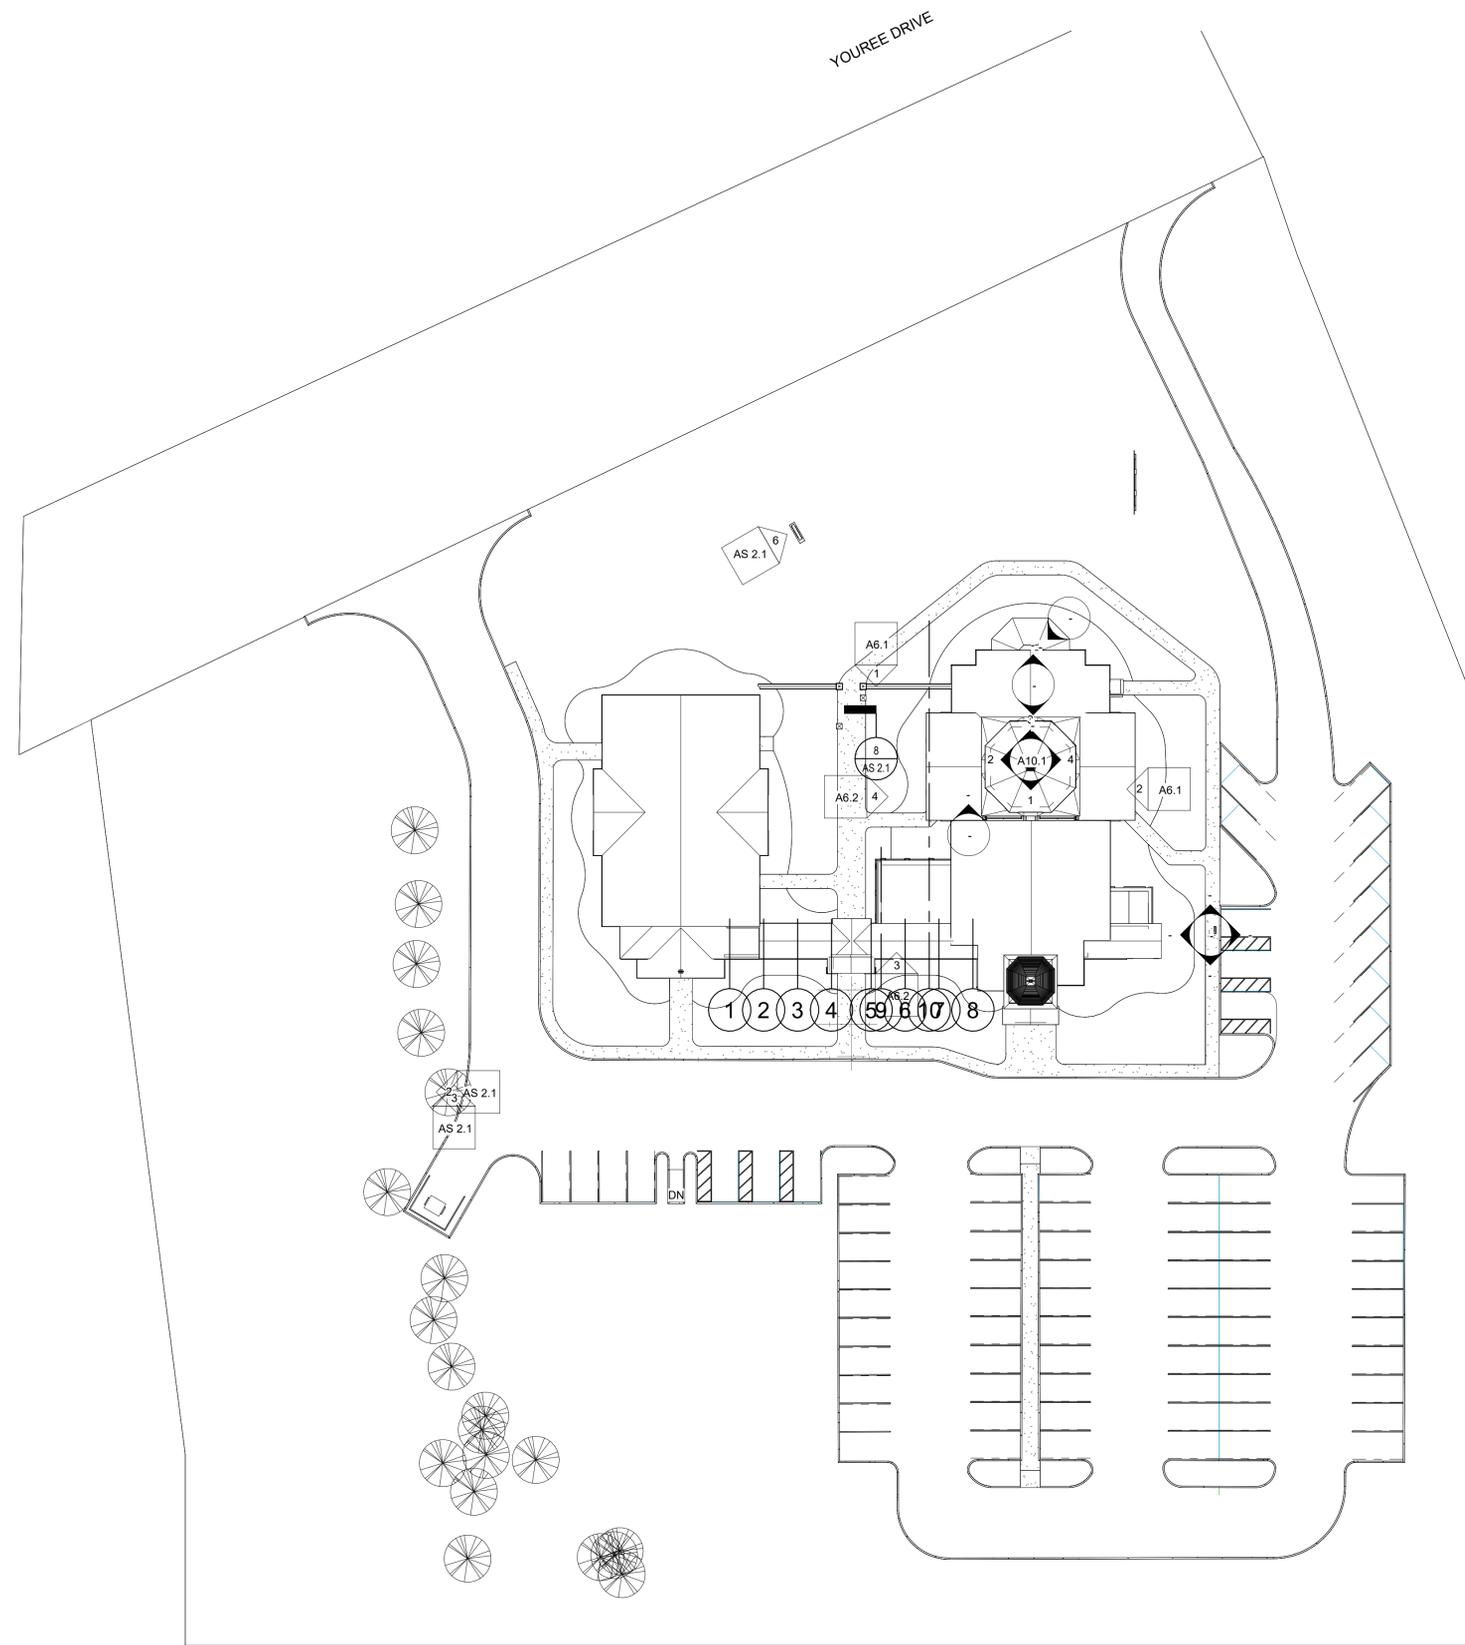
**AS 1.1**

ARCHITECTURAL  
SITE PLAN

**PRELIMINARY  
NOT FOR CONSTRUCTION**

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**1** SITE PLAN Copy 1  
SCALE: 1" = 30'-0"

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9100 Youree Dr, Shreveport, LA 71115

Date:	10/31/2025
REVISION	DATE

Drawn by: LCM  
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Sheet:


**AS 1.2**

ARCHITECTURAL  
SITE PLAN Copy 1

**PRELIMINARY  
NOT FOR CONSTRUCTION**

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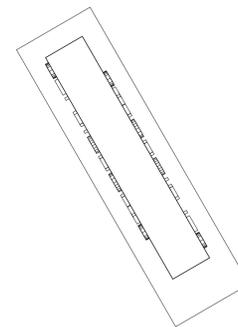
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**6** MONUMENT SIGN ELEVATION  
SCALE: 1/2" = 1'-0"

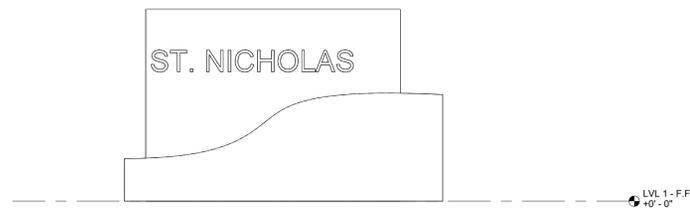


**8** BRICK ENTRNACE WALL  
SCALE: 1 1/2" = 1'-0"



**3** DUMPSTER ENCLOSURE  
SCALE: 1/4" = 1'-0"

**2** DUMPSTER ENCLOSURE GATE  
SCALE: 1/4" = 1'-0"

**5** MONUMENT SIGN  
SCALE: 1/2" = 1'-0"

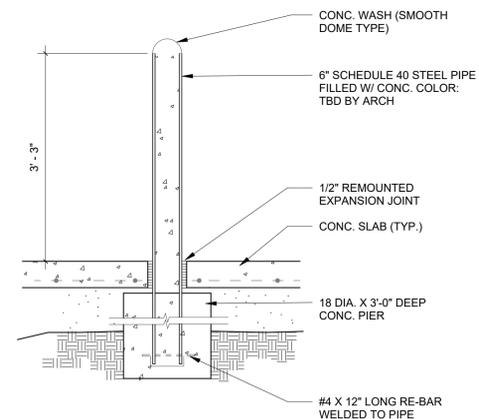

**4** BOLLARD DETAIL  
SCALE: 3/4" = 1'-0"



**7** BRICK ENTRANCE WALL PLAN  
SCALE: 1 1/2" = 1'-0"

**1** DUMPSTER ENCLOSURE  
SCALE: 1/4" = 1'-0"

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9100 Youree Dr, Shreveport, LA 71115

Date: 10/31/2025  
REVISION DATE

Drawn by: LCM  
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Project #: 2505  
Sheet:

**AS 2.1**

ARCHITECTURAL SITE DETAILS

2 AS 2.1

3 AS 2.1

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# GENERAL NOTES - DIMENSION PLAN

- A. CONSTRUCTION AND INSTALLATIONS SHALL CONFORM TO ALL FEDERAL, STATE AND LOCAL ORDINANCES, CODES, ETC.
- B. DIMENSION PLANS ARE INTENDED TO SHOW DIMENSIONS AND WALL TYPES, WALL RATINGS, WALL SECTIONS, BUILDING SECTION INDICATORS, EXTERIOR ELEVATION INDICATORS, PLAN DETAIL INDICATORS, AND DIMENSION PLAN KEY NOTES. REFER TO THE ARCHITECTURAL PLANS FOR ADDITIONAL PLAN KEY NOTES, INTERIOR ELEVATION MARKS AND INFORMATION RELATED TO OTHER ASPECTS OF THE PROJECT.
- C. ALL DIMENSIONS ARE TAKEN FROM COLUMN CENTERLINES TO THE FACE OF FINISH, FACE OF MASONRY, CONCRETE, OR EXISTING FINISHES, UNLESS NOTED OTHERWISE.
- D. VERIFY ALL CRITICAL DIMENSIONS WITHIN AND/OR RELATED TO THE SITE AND/OR EXISTING BUILDING, DIMENSIONS AND CONDITIONS INDICATED WERE DETERMINED BY VISUAL SURVEY. CONTRACTOR SHALL OBTAIN AND VERIFY ALL DIMENSIONS AND CONDITIONS AT JOB SITE AND BE FULLY RESPONSIBLE FOR THE SAME. IF DISCREPANCY IS FOUND, THE CONTRACTOR SHALL CONTACT THE ARCHITECT AND THE ARCHITECT SHALL DETERMINE THE CRITICAL DIMENSIONS TO BE HELD. THE CONTRACTOR SHALL SUBMIT TO THE ARCHITECT, FOR REVIEW, A DIMENSIONED INTERIOR WALL LAYOUT PRIOR TO ANY INTERIOR WALL CONSTRUCTION.
- E. DIMENSIONS ARE TAKEN TO THE 4'-0" PLANE ABOVE FINISHED FLOOR.
- F. ALL NEW INTERIOR PARTITIONS SHALL BE WALL TYPE "A3D" UNLESS OTHERWISE INDICATED.
- G. ALL FIRE RATED ASSEMBLIES WITH RECESSED WALL ACCESSORIES AND/OR PENETRATIONS, I.E. RECEPTACLES, CONDUITS, DUCTS, PIPING, FIRE EXTINGUISHER CABINETS, RECESSED FILM VIEWERS, PAPER TOWEL DISPENSER, ETC. SHALL BE CONSTRUCTED TO MAINTAIN THE DESIGNATED RATED ASSEMBLY.
- I. FINISHED FLOOR ELEVATIONS ARE FROM THE FACE OF THE FINISHED SUBSTRATE, I.E. CONCRETE DECK, CONCRETE SLAB, ETC.
- K. VERIFY LOCATION AND SIZE OF ALL RECESSES, PLUMBING CHASES AND MECHANICAL SHAFTS PRIOR TO CONSTRUCTION.
- L. ALL EXTERIOR WALLS SHALL BE FRAMED OUT OF 16 GAUGE, 6" METAL STUD AT 16" ON CENTER, UNLESS NOTED OTHERWISE. REFER TO THE STRUCTURAL DRAWINGS.
- M. INSTALL MINERAL WOOL INSULATION IN ALL EXPANSION JOINTS THROUGH THE FLOOR AND ROOF SLABS, CONTINUOUS. PROVIDE FIRE RATED EXPANSION JOINTS WITH MINERAL WOOL INSULATION BLANKET AT ALL RATED ASSEMBLIES.
- N. ALL INTERIOR MASONRY WALLS SHALL BE RUNNING BOND PATTERN UNLESS NOTED OTHERWISE.
- O. ALL PENETRATIONS THROUGH FLOORS, CHASES, SHAFTS AND FIRE RATED ASSEMBLIES SHALL BE SLEEVED PER THE REQUIRED TEST AND FIRE STOPPED.
- P. ALL PENETRATIONS THROUGH FLOOR SLABS, I.E. CONDUITS, DUCTS, PIPING, PNEUMATIC TUBE, ETC. SHALL BE FIRE STOPPED AND SEALED AS REQUIRED TO PROVIDE THE ASSEMBLY RATED DESIGNATED AND SHALL BE WATERTIGHT.
- Q. PROVIDE FULL HEIGHT METAL STUDS (20 GAUGE MINIMUM) TO THE FLOOR OR ROOF DECK ABOVE AT ALL CORNERS, DOOR FRAMES, BORROWED LIGHTS FRAME, BEHIND WALL MOUNTED EQUIPMENT AND BEHIND WALL MOUNTED CASEWORK.
- R. ALL TRADES ARE REQUIRED TO VISIT THE SITE AND DETERMINE THAT ALL WORK CAN BE ACHIEVED IN A COMPLETE MANNER UNDER THEIR BID.
- S. EXTENDED CMU PARTITIONS TO UNDERSIDE OF STRUCTURAL DECK ABOVE. TERMINATE PARTITION FROM THE STRUCTURE. PACK MINERAL WOOL INSULATION IN VOID SPACE BETWEEN TOP OF WALL AND STRUCTURAL DECK.
- T. PACK MINERAL WOOL INSULATION IN VOID SPACE BETWEEN STRUCTURAL DECK AND TOP OF ALL FIRE-RATED ASSEMBLIES. PROVIDE FIRE-RATED SEALANT AT ALL FIRE-RATED ASSEMBLIES.
- U. ALL INTERIOR WALLS, INCLUDING THE METAL STUD FRAMING, ACUSTICAL INSULATION AND GYPSUM WALLBOARD SHALL EXTEND UP TO THE FLOOR OR ROOF DECK ABOVE.
- V. ALL NEW OR EXISTING SOUND, SMOKE OR FIRE RATED WALLS SHALL EXTEND FROM FLOOR SUBSTRATE TO THE UNDERSIDE OF FLOOR OR ROOF DECK ABOVE AND SHALL BE FULLY FIRE STOPPED AND SEALED AS REQUIRED TO PROVIDE THE ASSEMBLY RATING DESIGNATED.
- W. ALL VERTICAL OR HORIZONTAL DUCTS, PIPING, CONDUIT, ETC. (SHOWN OR NOT) SHALL BE BOXED OUT TO MATCH ADJACENT WALL CONSTRUCTION.
- X. RATED WALL DESIGNATIONS ARE SHOWN THROUGH OPENINGS TO INDICATE THAT THE WALL CONSTRUCTION ABOVE THE OPENING HAS THE SAME RATING AS THE CONSTRUCTION ON EITHER SIDE OF OPENING.
- Y. PROVIDE ACCESS PANELS IN WALLS WHERE SERVICE TO MECHANICAL, PLUMBING, ELECTRICAL, ETC. ELEMENTS WILL NEED TO BE ADJUSTED, I.E. CLEAN OUTS, VALVES, DAMPERS, ETC. ACCESS PANELS SHALL BE OF THE SAME RATING AS THE ADJACENT WALL CONSTRUCTION.
- Z. PROVIDE BLOCKING BEHIND ALL WALL MOUNTED HANDRAILS, BUMPER RAILS, TOILET ACCESSORIES, SCONCES, ETC.
- AA. ALL CORRIDORS, HALLWAYS, PASSAGES, ETC. WALLS SHALL BE CONSTRUCTED TO BE SMOKE TIGHT AND SMOKE RESISTANT UNLESS NOTED OTHERWISE.
- AB. REFER TO A2.0 SHEET FOR PLAN SYMBOLS LEGEND.
- AC. REFER TO A2.0 SHEET FOR WALL RATING ASSEMBLY DETAILS.

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PLAN NOTES	
NO.	NOTES

Date:	10/31/2025
REVISION	DATE


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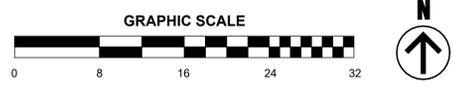
DIMENSION PLAN  
 - 1ST FLOOR

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Area Schedule (Gross...)	
Area	Name
8,781 SF	New Temple
5,305 SF	Existing
610 SF	Colonnade



**1 DIMENSION PLAN - 1ST FLOOR**  
 SCALE: 1/8" = 1'-0"

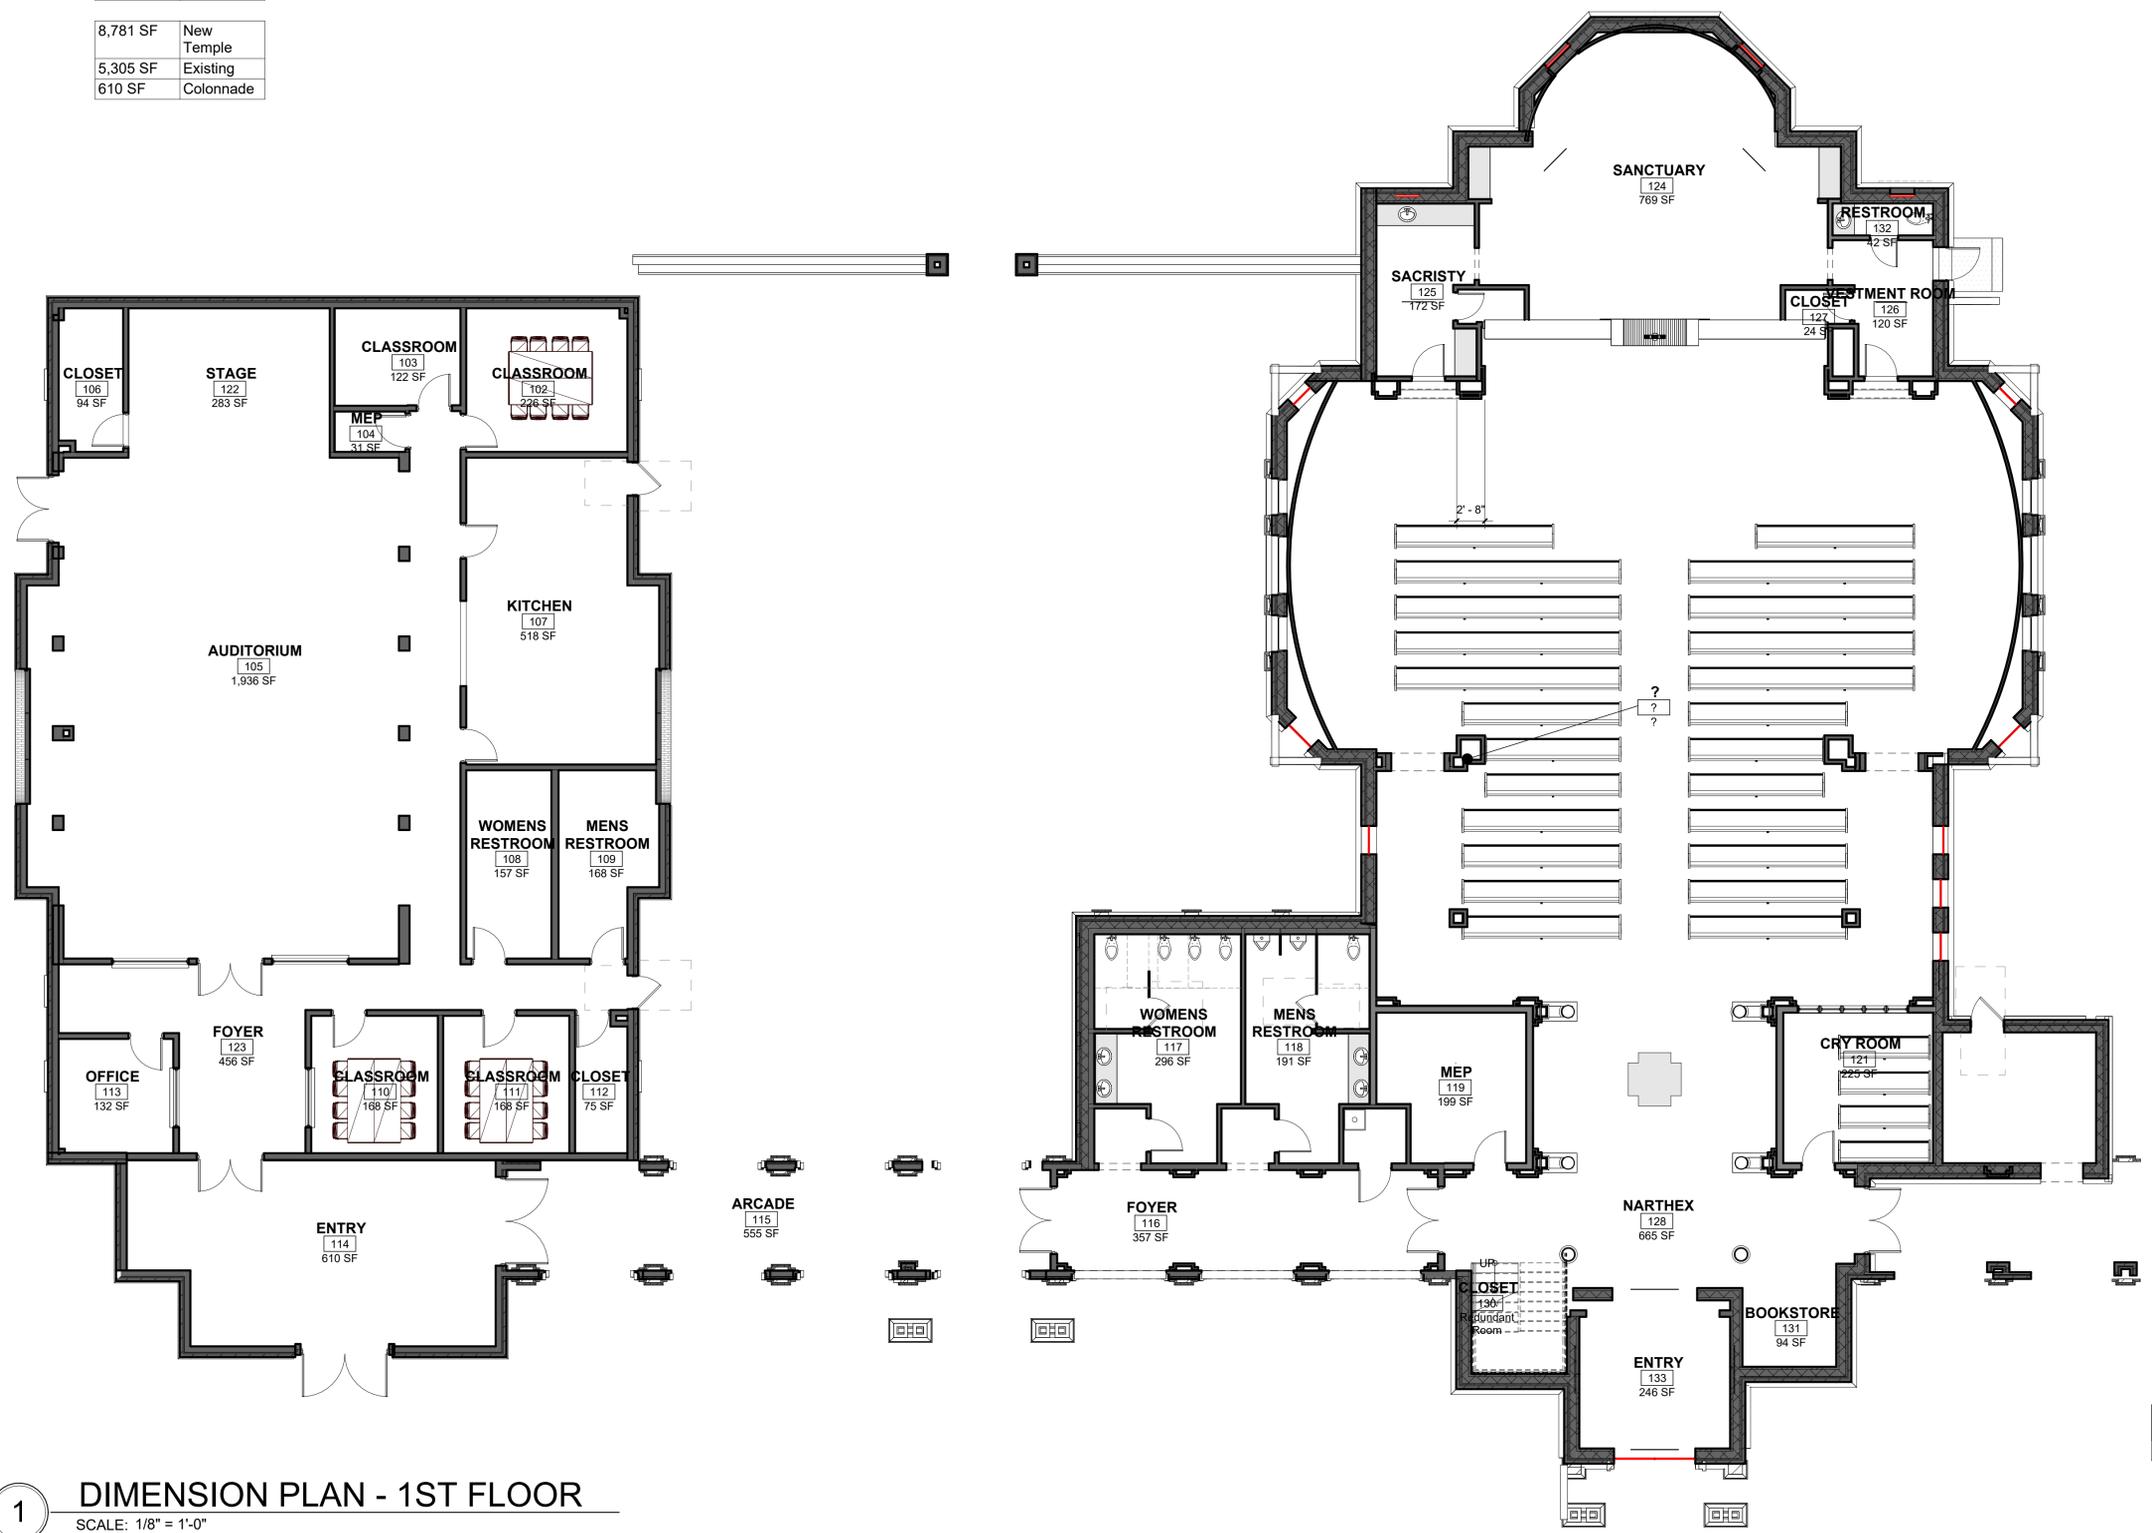

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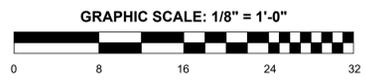
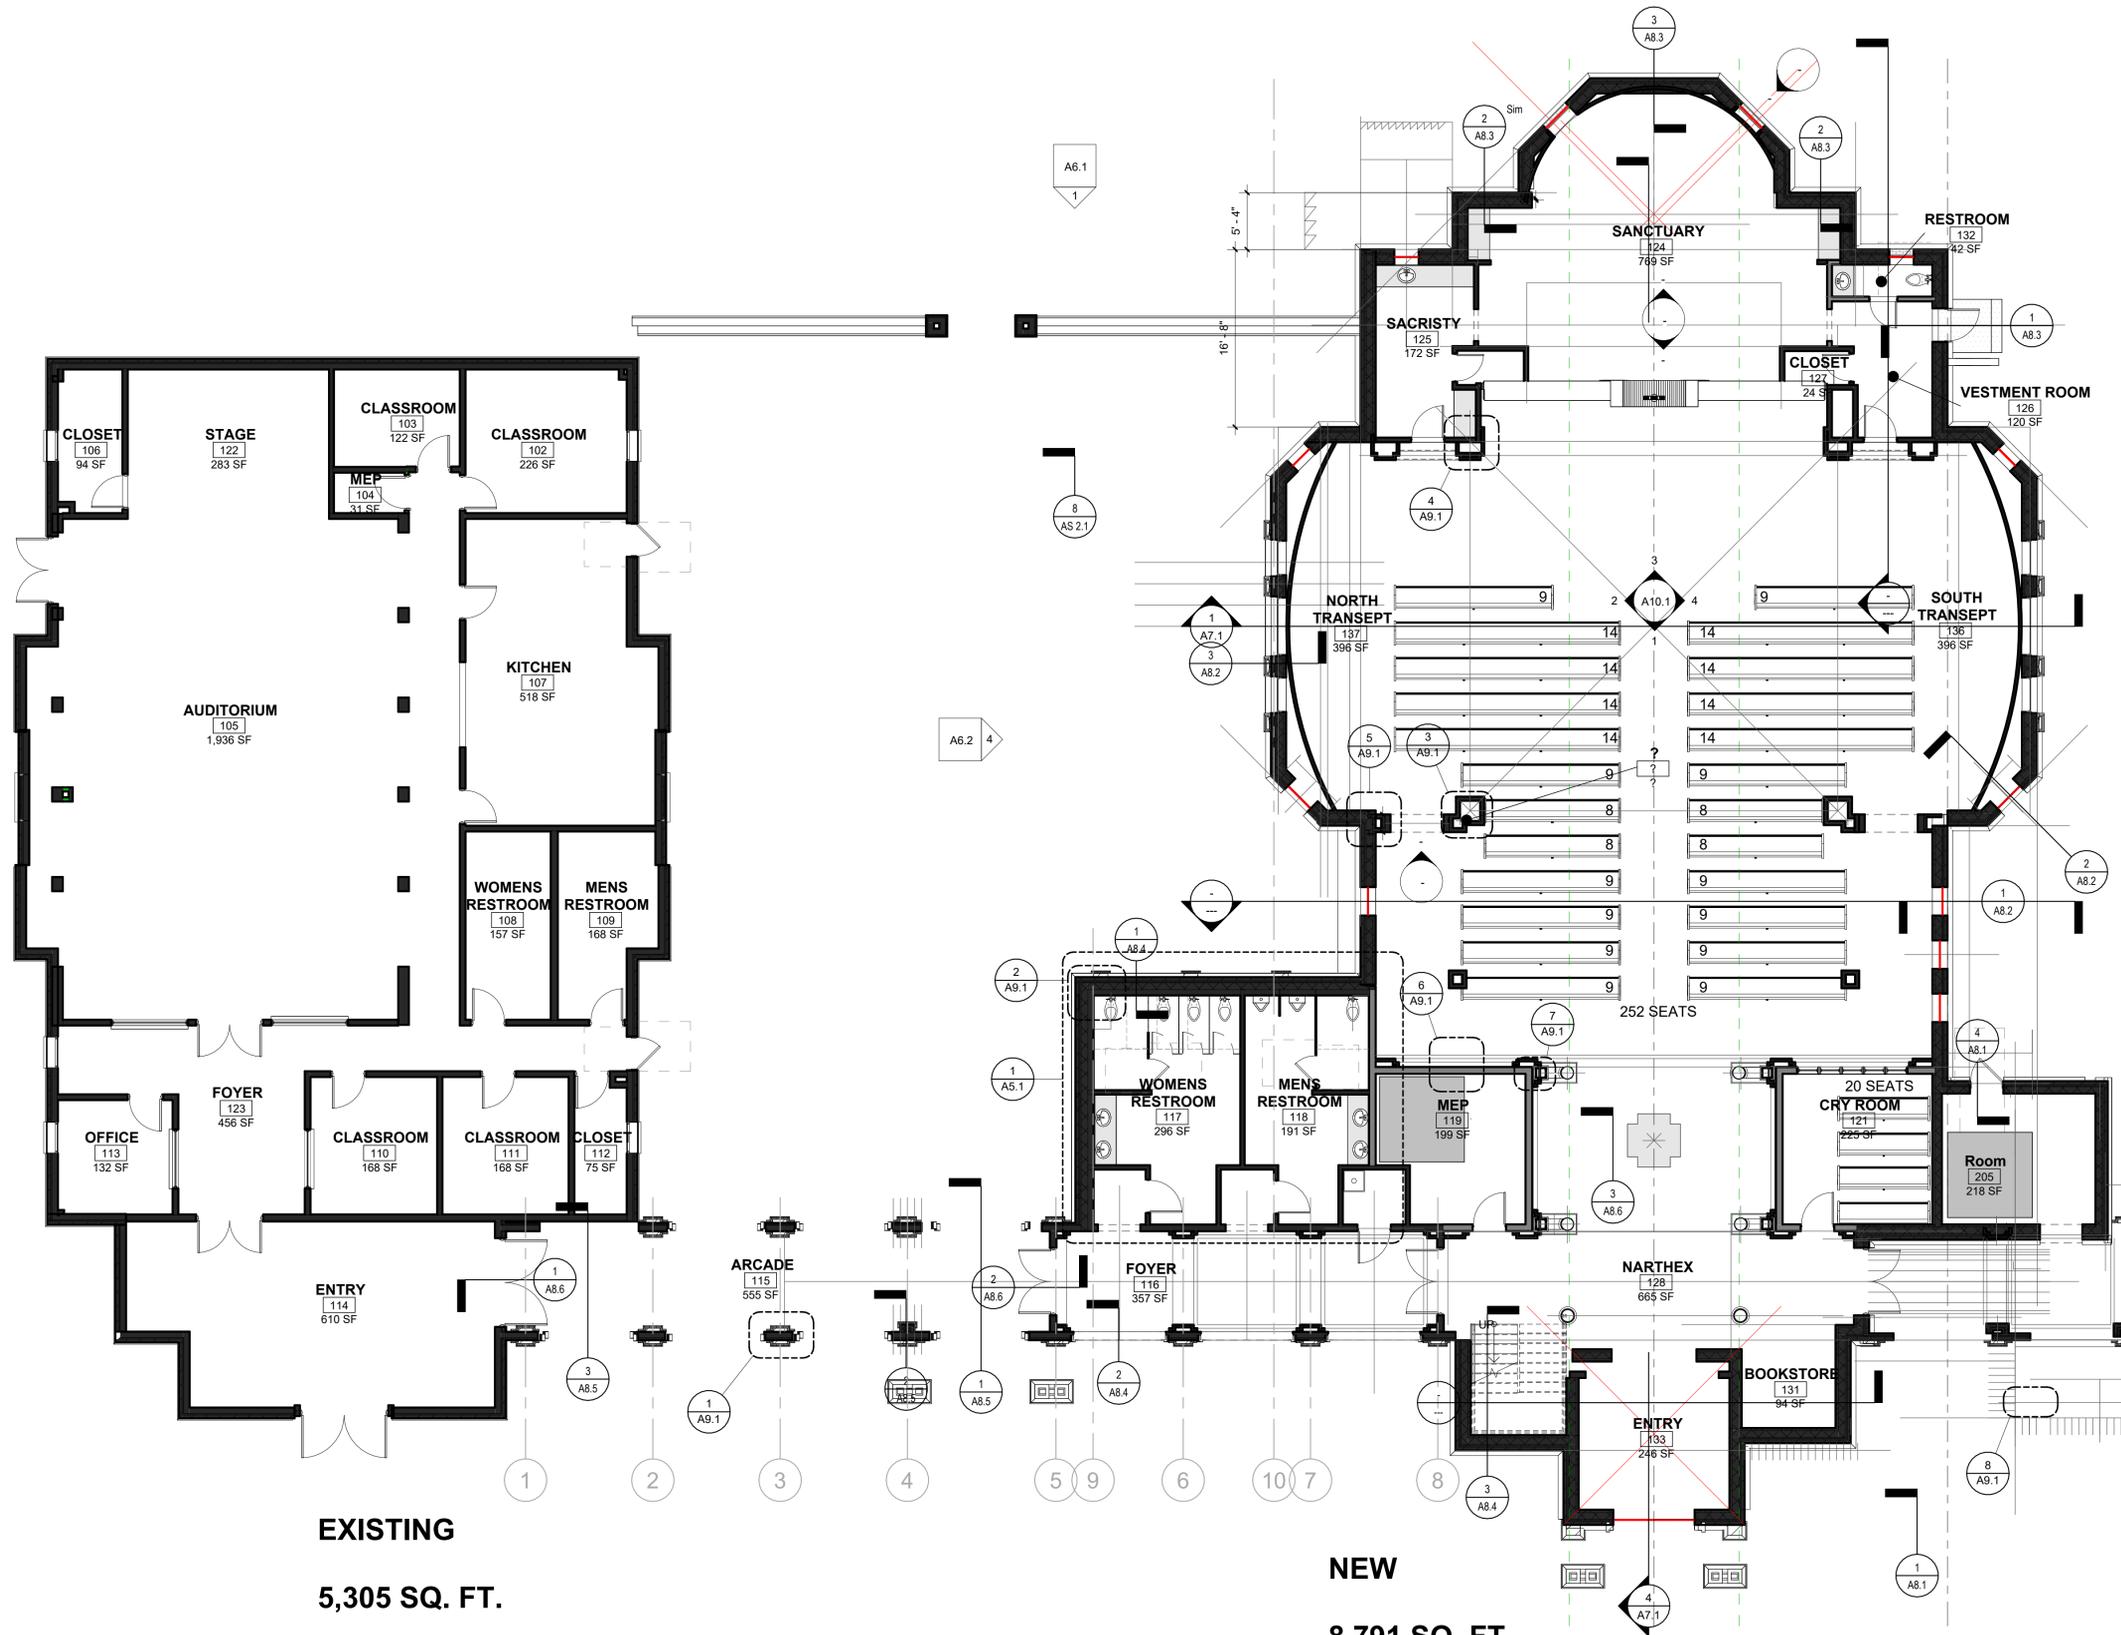
### WALL RATINGS LEGEND:

**NOTES:**  
 A. RATED WALL DESIGNATIONS ARE DRAWN THROUGH OPENINGS TO INDICATE THAT THE WALL CONSTRUCTION ABOVE THE OPENING HAS THE SAME RATING AS THE CONSTRUCTION ON EITHER SIDE OF OPENING. THE CONTRACTOR MUST SUBMIT DOCUMENTATION WHEN RATED WALL ASSEMBLY HAS BEEN TESTED AND APPROVED BY AGENCY OTHER THAN U.L.  
 B.

	NON RATED SMOKE PARTITION - UL	
	DOOR AND FRAME	- NOT RATED
	DAMPERS	- NOT REQUIRED
	PENETRATIONS/PERIMETER	- SEALED
	ONE HOUR FIRE BARRIER - UL	
	DOOR AND FRAME	- 45 MIN. RATING
	DAMPERS	- FIRE - SEE MECH. CODE
	PENETRATIONS/PERIMETER	- FIRE CAULKED
	TWO HOUR FIRE BARRIER - UL	
	DOOR AND FRAME	- 90 MIN. RATING
	DAMPERS	- FIRE - SEE MECH. CODE
	PENETRATIONS/PERIMETER	- FIRE CAULKED
	FIRE/SMOKE BARRIER	
	DOOR AND FRAME	- 20 MIN. RATING
	DAMPERS	- SMOKE - SEE MECH. CODE
	PENETRATIONS/PERIMETER	- FIRE CAULKED
	ONE HOUR FIRE/SMOKE BARRIER	
	DOOR AND FRAME	- 45 MIN. RATING
	DAMPERS	- FIRE AND SMOKE - SEE MECH. CODE
	PENETRATIONS/PERIMETER	- FIRE CAULKED
	TWO HOUR FIRE/SMOKE BARRIER	
	DOOR AND FRAME	- 90 MIN. RATING
	DAMPERS	- FIRE AND SMOKE - SEE MECH. CODE
	PENETRATIONS/PERIMETER	- FIRE CAULKED

### SYMBOLS:

	SECTION/DETAIL DESIGNATION
	DETAIL OR SECTION NUMBER
	SHEET NUMBER
	ENLARGED PLAN DETAIL DESIGNATION
	DETAIL OR SECTION NUMBER
	SHEET NUMBER
	ROOM NAME DESIGNATION
	ROOM NUMBER DESIGNATION
	ARCHITECTURAL PLAN KEY NOTE DESIGNATION
	EXTERIOR OPENING DESIGNATION (WINDOW AND LOUVERS)
	TOILET ACCESSORY DESIGNATION
	EQUIPMENT DESIGNATION
	ELEVATION INDICATOR
	OPENING NUMBER DESIGNATION
	DOOR ACTUATOR
	EXISTING COLUMN CENTER LINE
	NEW COLUMN CENTER LINE
	CORNER GUARD LOCATIONS
	HANDRAIL/BUMPGUARD AND/OR TRIM. REFER TO THE ARCHITECTURAL PLANS AND THE INTERIOR ELEVATIONS FOR LOCATIONS.
	WALL TYPE SUFFIX
	WALL TYPE
	WALL TYPE DESIGNATION AS INDICATED ON DIMENSION PLANS
	WALL TYPE DESIGNATION FOR FIRE RATED/ACOUSTIC PARTITIONS
	STC RATING



**1 ARCHITECTURAL PLAN - 1ST FLOOR**  
 SCALE: 1/8" = 1'-0"

**SOMDAL ASSOCIATES**  
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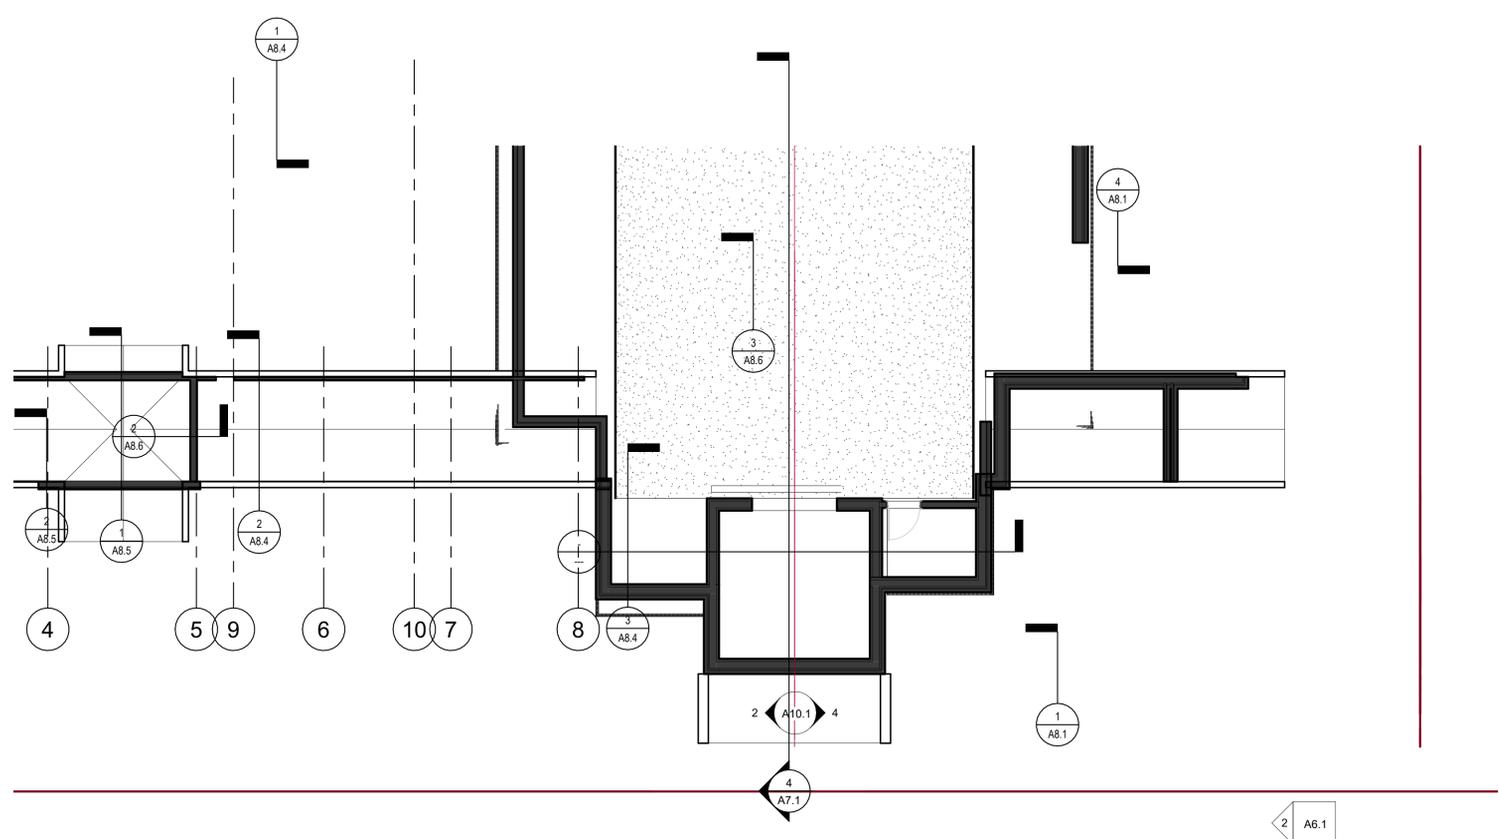
**A2.1**

ARCHITECTURAL PLAN - 1ST FLOOR


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**2** 2ND - REFLECTED CEILING PLAN  
SCALE: 1/8" = 1'-0"



**1** 2ND - ARCH  
SCALE: 1/8" = 1'-0"

**WALL RATINGS LEGEND:**

**NOTES:**

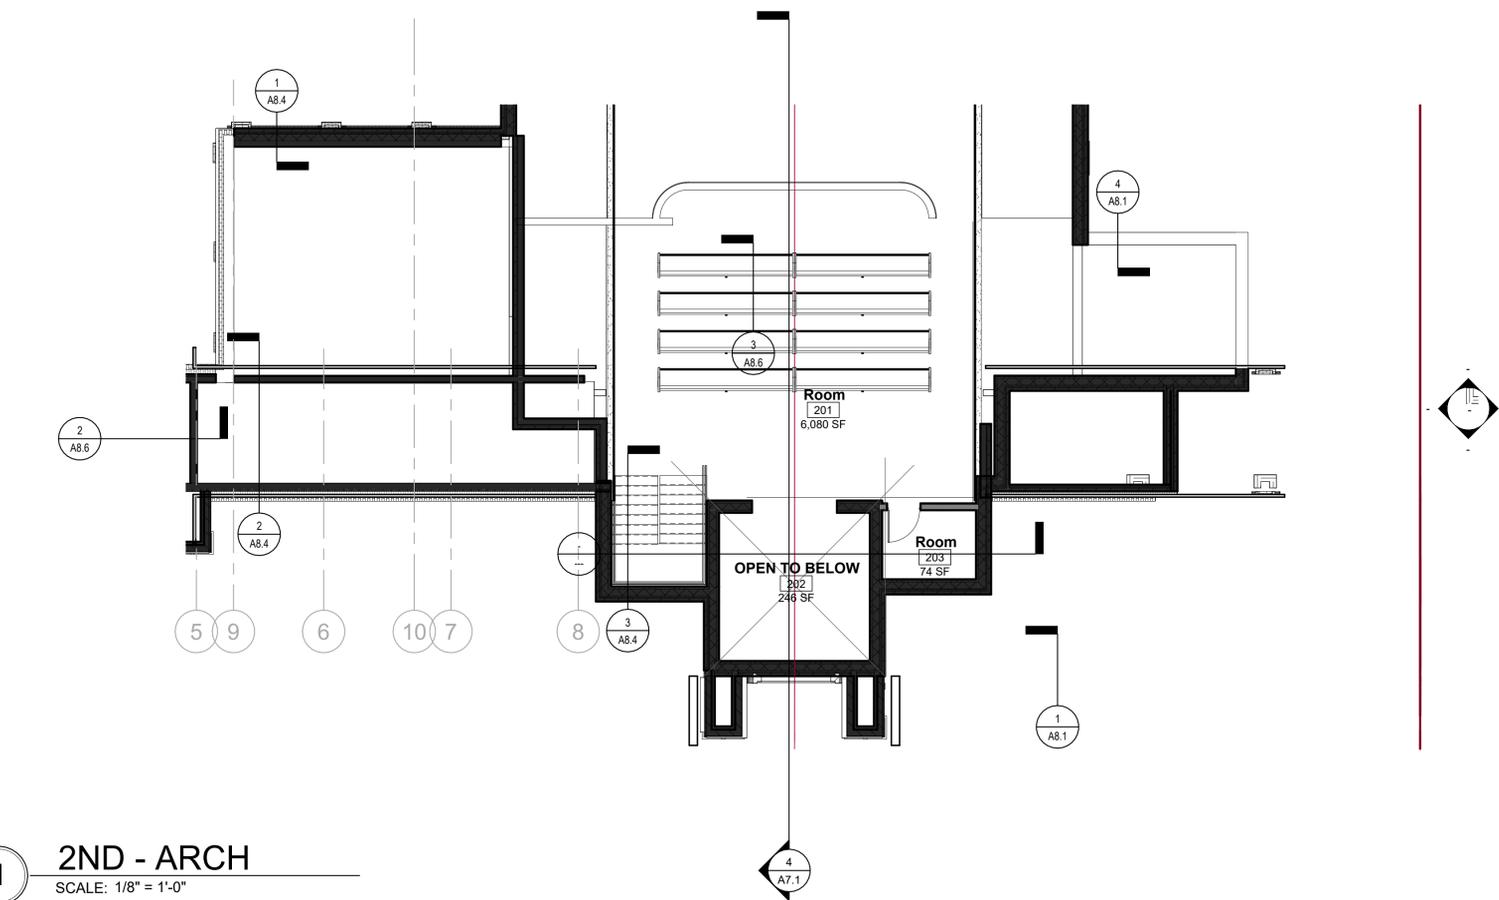A. RATED WALL DESIGNATIONS ARE DRAWN THROUGH OPENINGS TO INDICATE THAT THE WALL CONSTRUCTION ABOVE THE OPENING HAS THE SAME RATING AS THE CONSTRUCTION ON EITHER SIDE OF OPENING. THE CONTRACTOR MUST SUBMIT DOCUMENTATION WHEN RATED WALL ASSEMBLY HAS BEEN TESTED AND APPROVED BY AGENCY OTHER THAN U.L.

B. NON RATED SMOKE PARTITION - U.L.  
DOOR AND FRAME - NOT RATED  
DAMPERS - NOT REQUIRED  
PENETRATIONS/PERIMETER - SEALED

ONE HOUR FIRE BARRIER - U.L.  
DOOR AND FRAME - 45 MIN. RATING  
DAMPERS - FIRE - SEE MECH. CODE  
PENETRATIONS/PERIMETER - FIRE CAULKED  
EXTEND ENTIRE WALL CONSTRUCTION TO DECK ABOVE.

TWO HOUR FIRE BARRIER - U.L.  
DOOR AND FRAME - 90 MIN. RATING  
DAMPERS - FIRE - SEE MECH. CODE  
PENETRATIONS/PERIMETER - FIRE CAULKED  
EXTEND ENTIRE WALL CONSTRUCTION TO DECK ABOVE.

FIRE/SMOKE BARRIER  
DOOR AND FRAME - 20 MIN. RATING  
DAMPERS - SMOKE - SEE MECH. CODE  
PENETRATIONS/PERIMETER - FIRE CAULKED  
EXTEND ENTIRE WALL CONSTRUCTION TO DECK ABOVE (ONE HOUR WALL CONSTRUCTION)

ONE HOUR FIRE/SMOKE BARRIER  
DOOR AND FRAME - 45 MIN. RATING  
DAMPERS - FIRE AND SMOKE - SEE MECH. CODE  
PENETRATIONS/PERIMETER - FIRE CAULKED  
EXTEND ENTIRE WALL CONSTRUCTION TO DECK ABOVE.

TWO HOUR FIRE/SMOKE BARRIER  
DOOR AND FRAME - 90 MIN. RATING  
DAMPERS - FIRE AND SMOKE - SEE MECH. CODE  
PENETRATIONS/PERIMETER - FIRE CAULKED  
EXTEND ENTIRE WALL CONSTRUCTION TO DECK ABOVE.

**SYMBOLS:**

**SECTION/DETAIL DESIGNATION:**

1 A101 - DETAIL OR SECTION NUMBER  
SHEET NUMBER

**ENLARGED PLAN DETAIL DESIGNATION:**

X Ref AX.X - DETAIL OR SECTION NUMBER  
SHEET NUMBER

AREA OF DETAIL ENLARGEMENT

**ROOM**  
101  
150 SF - ROOM NAME DESIGNATION  
ROOM NUMBER DESIGNATION

401 - ARCHITECTURAL PLAN KEY  
NOTE DESIGNATION

4 A8.1 - EXTERIOR OPENING DESIGNATION  
(WINDOW AND LOUVERS)

1 - TOILET ACCESSORY DESIGNATION

EXXX - EQUIPMENT DESIGNATION

1 Ref - ELEVATION INDICATOR

Opening Number Designation  
Door Actuator

Existing Column Center Line

New Column Center Line

CG CG - CORNER GUARD LOCATIONS

HANDRAIL/BUMPGUARD AND/OR TRIM, REFER TO THE ARCHITECTURAL PLANS AND THE INTERIOR ELEVATIONS FOR LOCATIONS.

WALL TYPE SUFFIX  
WALL TYPE

W01 56 145 - WALL TYPE DESIGNATION AS INDICATED ON DIMENSION PLANS  
FIRE RATING  
STC RATING

WALL TYPE DESIGNATION FOR FIRE RATED/ACOUSTIC PARTITIONS

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ARCHITECTURE + INTERIOR DESIGN  
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NEW TEMPLE BUILDING FOR  
**ST. NICHOLAS ORTHODOX CHURCH**  
9100 Youree Dr, Shreveport, LA 71115

Date: 10/31/2025  
REVISION DATE

Drawn by: LCM / EBW  
Checked by: Checker  
Project #: 2505


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ARCHITECTURAL  
PLAN - 2ND  
FLOOR

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### WALL RATINGS LEGEND:

**NOTES:**  
 A. RATED WALL DESIGNATIONS ARE DRAWN THROUGH OPENINGS TO INDICATE THAT THE WALL CONSTRUCTION ABOVE THE OPENING HAS THE SAME RATING AS THE CONSTRUCTION ON EITHER SIDE OF OPENING. THE CONTRACTOR MUST SUBMIT DOCUMENTATION WHEN RATED WALL ASSEMBLY HAS BEEN TESTED AND APPROVED BY AGENCY OTHER THAN U.L.  
 B.

	<b>NON RATED SMOKE PARTITION - UL</b> DOOR AND FRAME DAMPERS PENETRATIONS/PERIMETER	- NOT RATED - NOT REQUIRED - SEALED
	<b>ONE HOUR FIRE BARRIER - UL</b> DOOR AND FRAME DAMPERS PENETRATIONS/PERIMETER	- 45 MIN. RATING - FIRE - SEE MECH. CODE - FIRE CAULKED
	<b>TWO HOUR FIRE BARRIER - UL</b> DOOR AND FRAME DAMPERS PENETRATIONS/PERIMETER	- 90 MIN. RATING - FIRE - SEE MECH. CODE - FIRE CAULKED
	<b>FIRE/SMOKE BARRIER</b> DOOR AND FRAME DAMPERS CODE PENETRATIONS/PERIMETER	- 20 MIN. RATING - SMOKE - SEE MECH. CODE - FIRE CAULKED
	<b>ONE HOUR FIRE/SMOKE BARRIER</b> DOOR AND FRAME DAMPERS PENETRATIONS/PERIMETER	- 45 MIN. RATING - FIRE AND SMOKE - SEE MECH. CODE - FIRE CAULKED
	<b>TWO HOUR FIRE/SMOKE BARRIER</b> DOOR AND FRAME DAMPERS PENETRATIONS/PERIMETER	- 90 MIN. RATING - FIRE AND SMOKE - SEE MECH. CODE - FIRE CAULKED

### SYMBOLS:

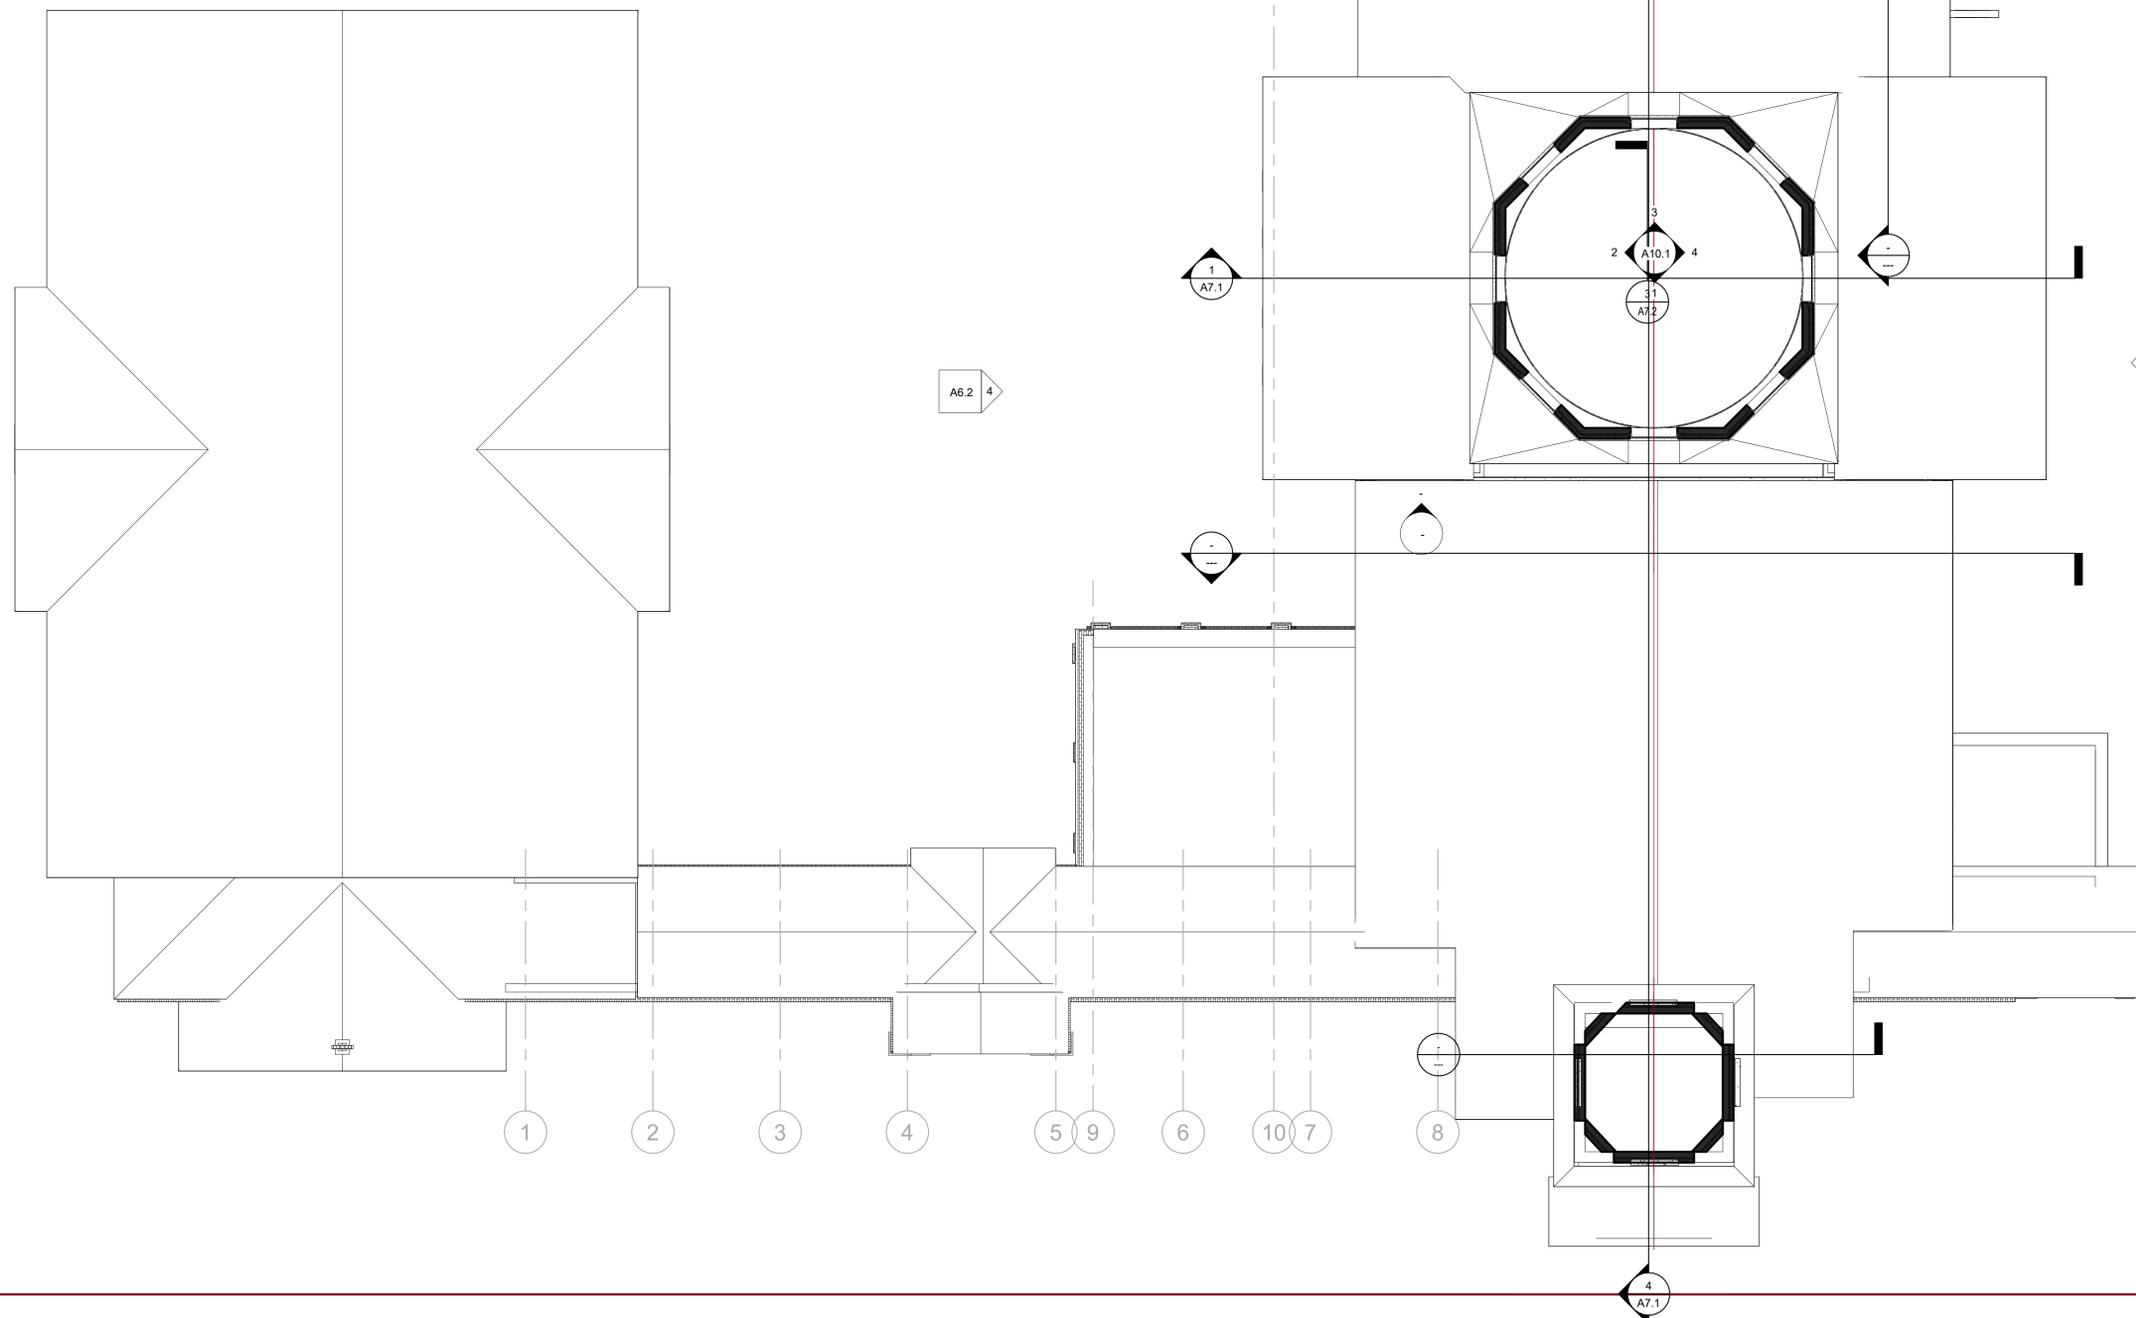	<b>SECTION/DETAIL DESIGNATION:</b> DETAIL OR SECTION NUMBER SHEET NUMBER
	<b>ENLARGED PLAN DETAIL DESIGNATION:</b> DETAIL OR SECTION NUMBER SHEET NUMBER
	<b>ROOM:</b> ROOM NAME DESIGNATION ROOM NUMBER DESIGNATION
	<b>ARCHITECTURAL PLAN KEY NOTE DESIGNATION</b>
	<b>EXTERIOR OPENING DESIGNATION (WINDOW AND LOUVERS)</b>
	<b>TOILET ACCESSORY DESIGNATION</b>
	<b>EQUIPMENT DESIGNATION</b>
	<b>ELEVATION INDICATOR</b>
	<b>OPENING NUMBER DESIGNATION DOOR ACTUATOR</b>
	<b>EXISTING COLUMN CENTER LINE</b>
	<b>NEW COLUMN CENTER LINE</b>
	<b>CORNER GUARD LOCATIONS</b>
	<b>HANDRAIL/BUMPGUARD AND/OR TRIM. REFER TO THE ARCHITECTURAL PLANS AND THE INTERIOR ELEVATIONS FOR LOCATIONS.</b>
	<b>WALL TYPE SUFFIX WALL TYPE</b> <b>WALL TYPE DESIGNATION AS INDICATED ON DIMENSION PLANS</b>
	<b>WALL TYPE DESIGNATION FOR FIRE RATED/ACOUSTIC PARTITIONS</b>

**1 UPPER DOME PLAN**  
SCALE: 1/8" = 1'-0"

**SOMDAL ASSOCIATES**  
ARCHITECTURE + INTERIOR DESIGN  
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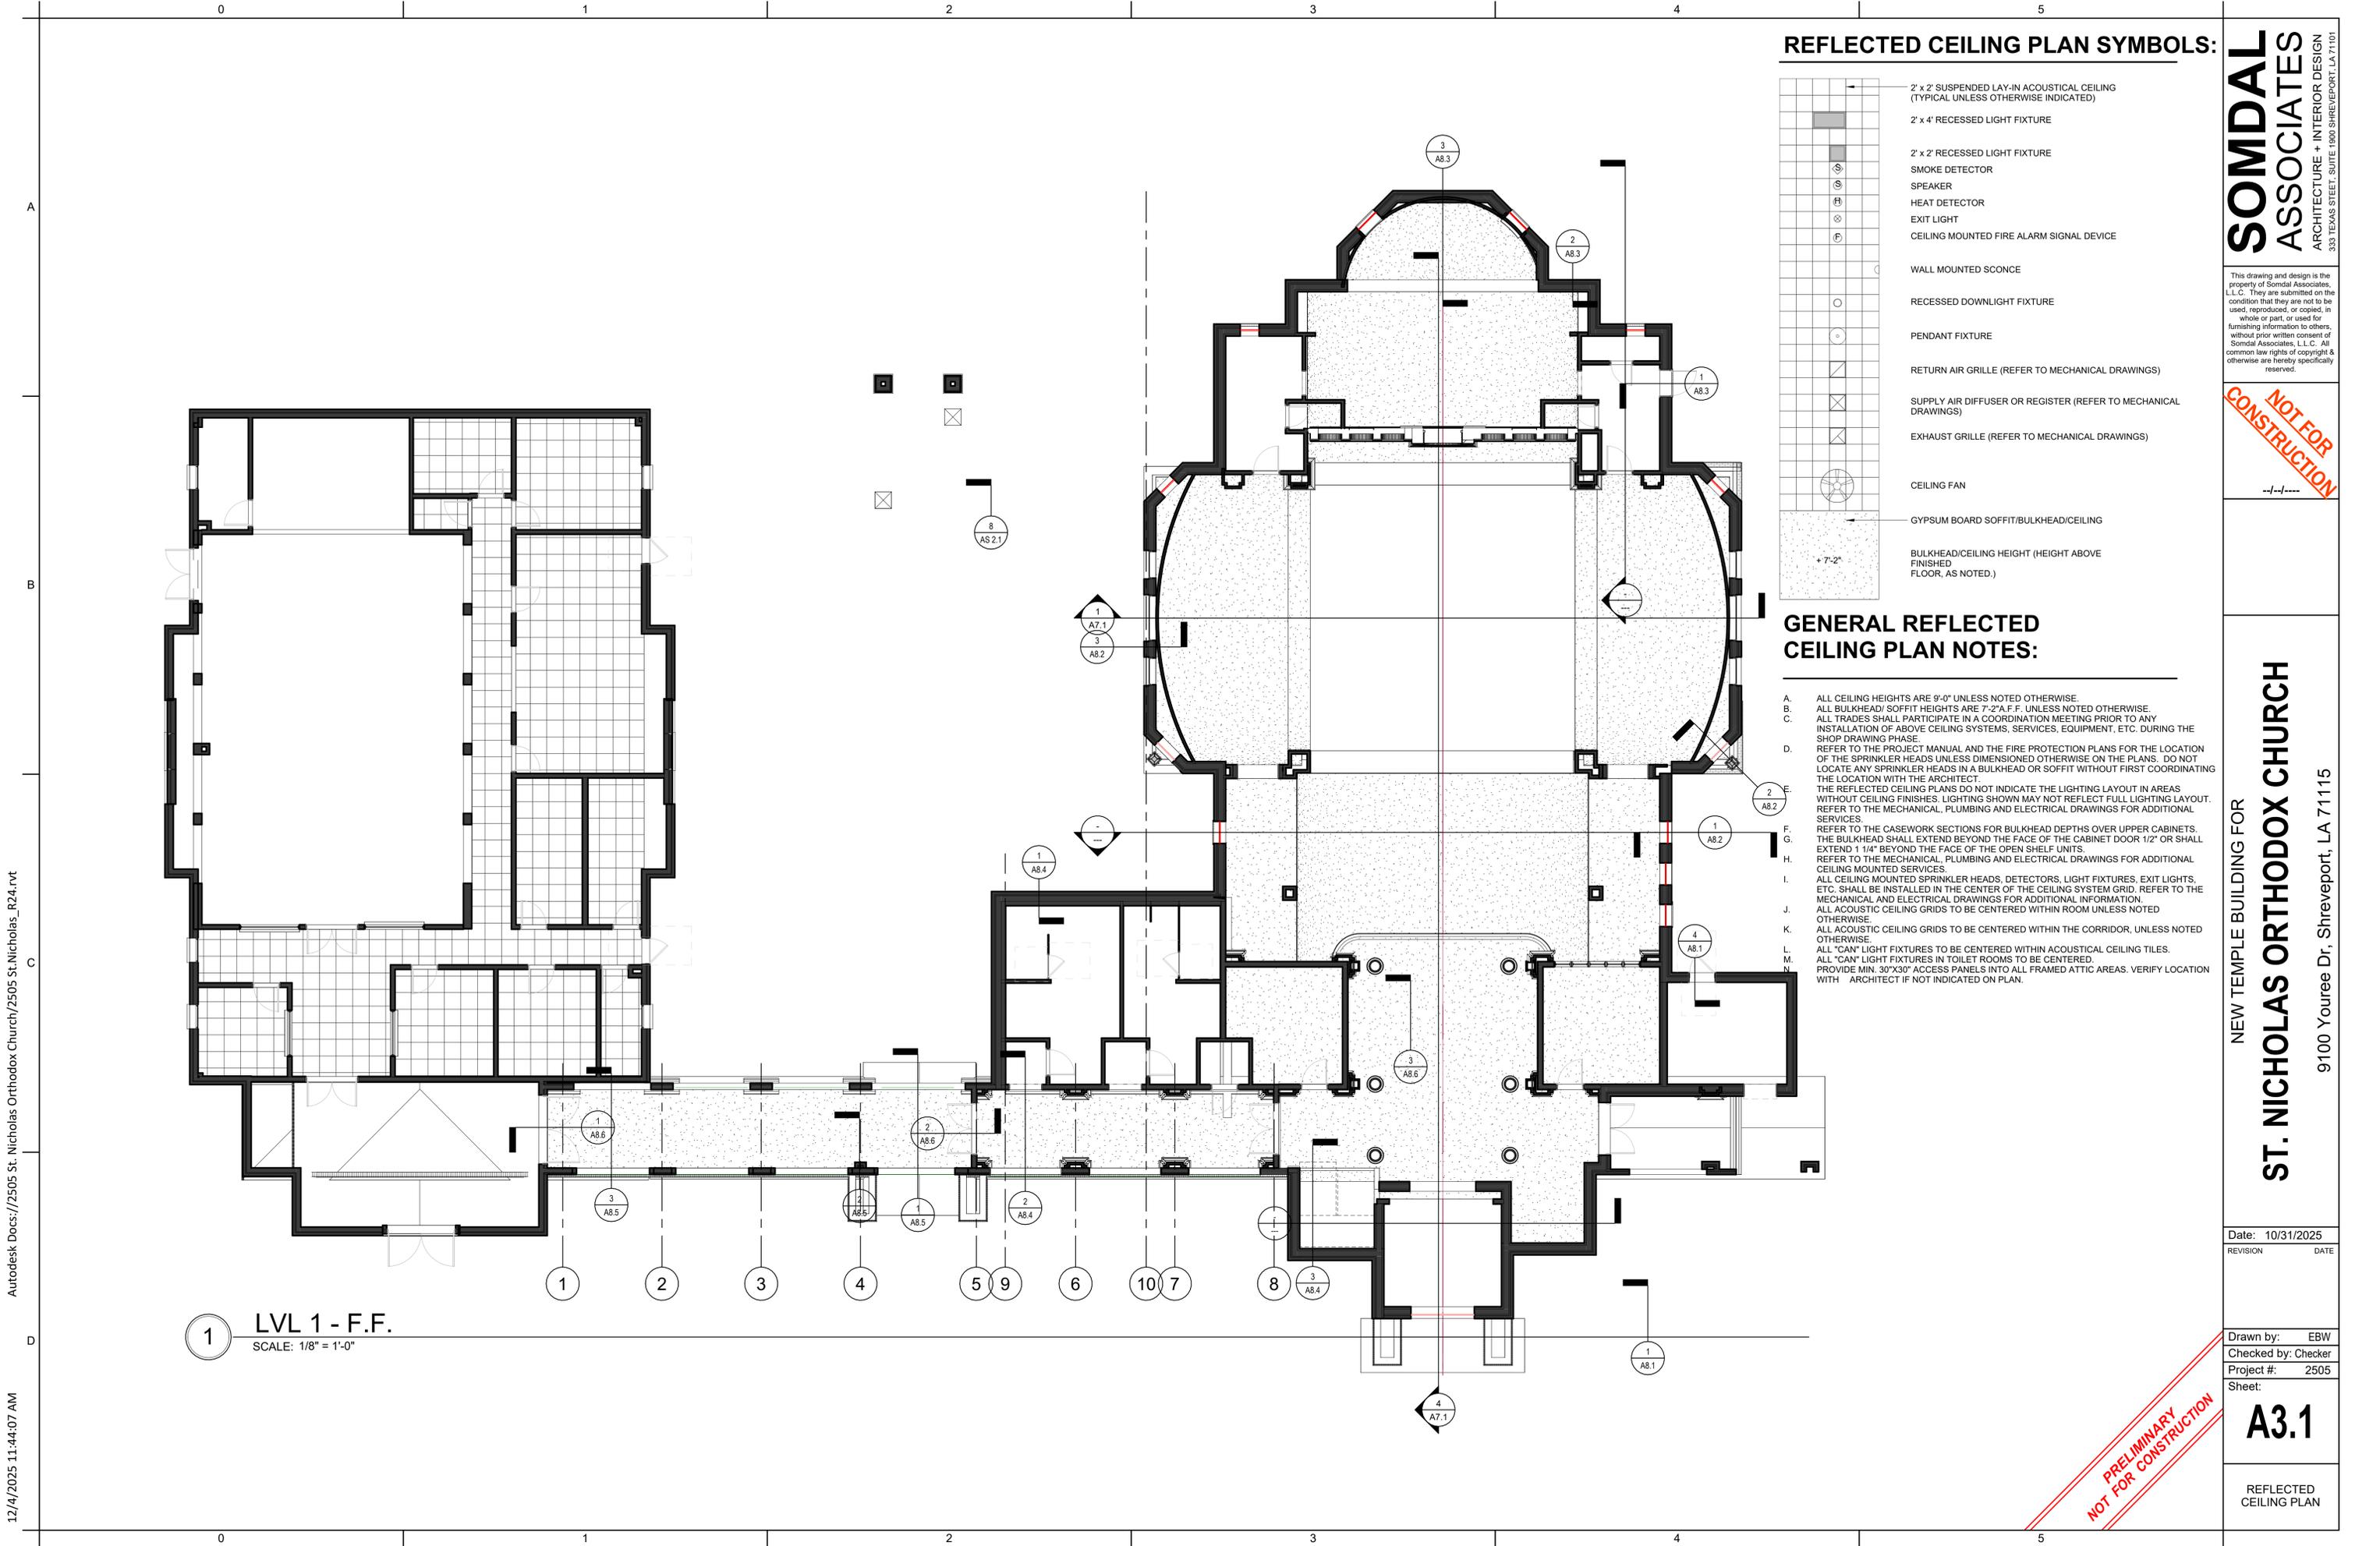
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ARCHITECTURAL PLAN - UPPER DOME

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**REFLECTED CEILING PLAN SYMBOLS:**

	2' x 2' SUSPENDED LAY-IN ACOUSTICAL CEILING (TYPICAL UNLESS OTHERWISE INDICATED)
	2' x 4' RECESSED LIGHT FIXTURE
	2' x 2' RECESSED LIGHT FIXTURE
	SMOKE DETECTOR
	SPEAKER
	HEAT DETECTOR
	EXIT LIGHT
	CEILING MOUNTED FIRE ALARM SIGNAL DEVICE
	WALL MOUNTED SCONCE
	RECESSED DOWNLIGHT FIXTURE
	PENDANT FIXTURE
	RETURN AIR GRILLE (REFER TO MECHANICAL DRAWINGS)
	SUPPLY AIR DIFFUSER OR REGISTER (REFER TO MECHANICAL DRAWINGS)
	EXHAUST GRILLE (REFER TO MECHANICAL DRAWINGS)
	CEILING FAN
	GYPSUM BOARD SOFFIT/BULKHEAD/CEILING
	BULKHEAD/CEILING HEIGHT (HEIGHT ABOVE FINISHED FLOOR, AS NOTED.)

**GENERAL REFLECTED CEILING PLAN NOTES:**

- A. ALL CEILING HEIGHTS ARE 9'-0" UNLESS NOTED OTHERWISE.
- B. ALL BULKHEAD/ SOFFIT HEIGHTS ARE 7'-2" A.F.F. UNLESS NOTED OTHERWISE.
- C. ALL TRADES SHALL PARTICIPATE IN A COORDINATION MEETING PRIOR TO ANY INSTALLATION OF ABOVE CEILING SYSTEMS, SERVICES, EQUIPMENT, ETC. DURING THE SHOP DRAWING PHASE.
- D. REFER TO THE PROJECT MANUAL AND THE FIRE PROTECTION PLANS FOR THE LOCATION OF THE SPRINKLER HEADS UNLESS DIMENSIONED OTHERWISE ON THE PLANS. DO NOT LOCATE ANY SPRINKLER HEADS IN A BULKHEAD OR SOFFIT WITHOUT FIRST COORDINATING THE LOCATION WITH THE ARCHITECT.
- E. THE REFLECTED CEILING PLANS DO NOT INDICATE THE LIGHTING LAYOUT IN AREAS WITHOUT CEILING FINISHES. LIGHTING SHOWN MAY NOT REFLECT FULL LIGHTING LAYOUT. REFER TO THE MECHANICAL, PLUMBING AND ELECTRICAL DRAWINGS FOR ADDITIONAL SERVICES.
- F. REFER TO THE CASEWORK SECTIONS FOR BULKHEAD DEPTHS OVER UPPER CABINETS. THE BULKHEAD SHALL EXTEND BEYOND THE FACE OF THE CABINET DOOR 1/2" OR SHALL EXTEND 1 1/4" BEYOND THE FACE OF THE OPEN SHELF UNITS.
- G. REFER TO THE MECHANICAL, PLUMBING AND ELECTRICAL DRAWINGS FOR ADDITIONAL CEILING MOUNTED SERVICES.
- H. ALL CEILING MOUNTED SPRINKLER HEADS, DETECTORS, LIGHT FIXTURES, EXIT LIGHTS, ETC. SHALL BE INSTALLED IN THE CENTER OF THE CEILING SYSTEM GRID. REFER TO THE MECHANICAL AND ELECTRICAL DRAWINGS FOR ADDITIONAL INFORMATION.
- I. ALL ACOUSTIC CEILING GRIDS TO BE CENTERED WITHIN ROOM UNLESS NOTED OTHERWISE.
- J. ALL ACOUSTIC CEILING GRIDS TO BE CENTERED WITHIN THE CORRIDOR, UNLESS NOTED OTHERWISE.
- K. ALL "CAN" LIGHT FIXTURES TO BE CENTERED WITHIN ACOUSTICAL CEILING TILES.
- L. ALL "CAN" LIGHT FIXTURES IN TOILET ROOMS TO BE CENTERED.
- M. PROVIDE MIN. 30"X30" ACCESS PANELS INTO ALL FRAMED ATTIC AREAS. VERIFY LOCATION WITH ARCHITECT IF NOT INDICATED ON PLAN.

**1 LVL 1 - F.F.**  
SCALE: 1/8" = 1'-0"

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REFLECTED CEILING PLAN

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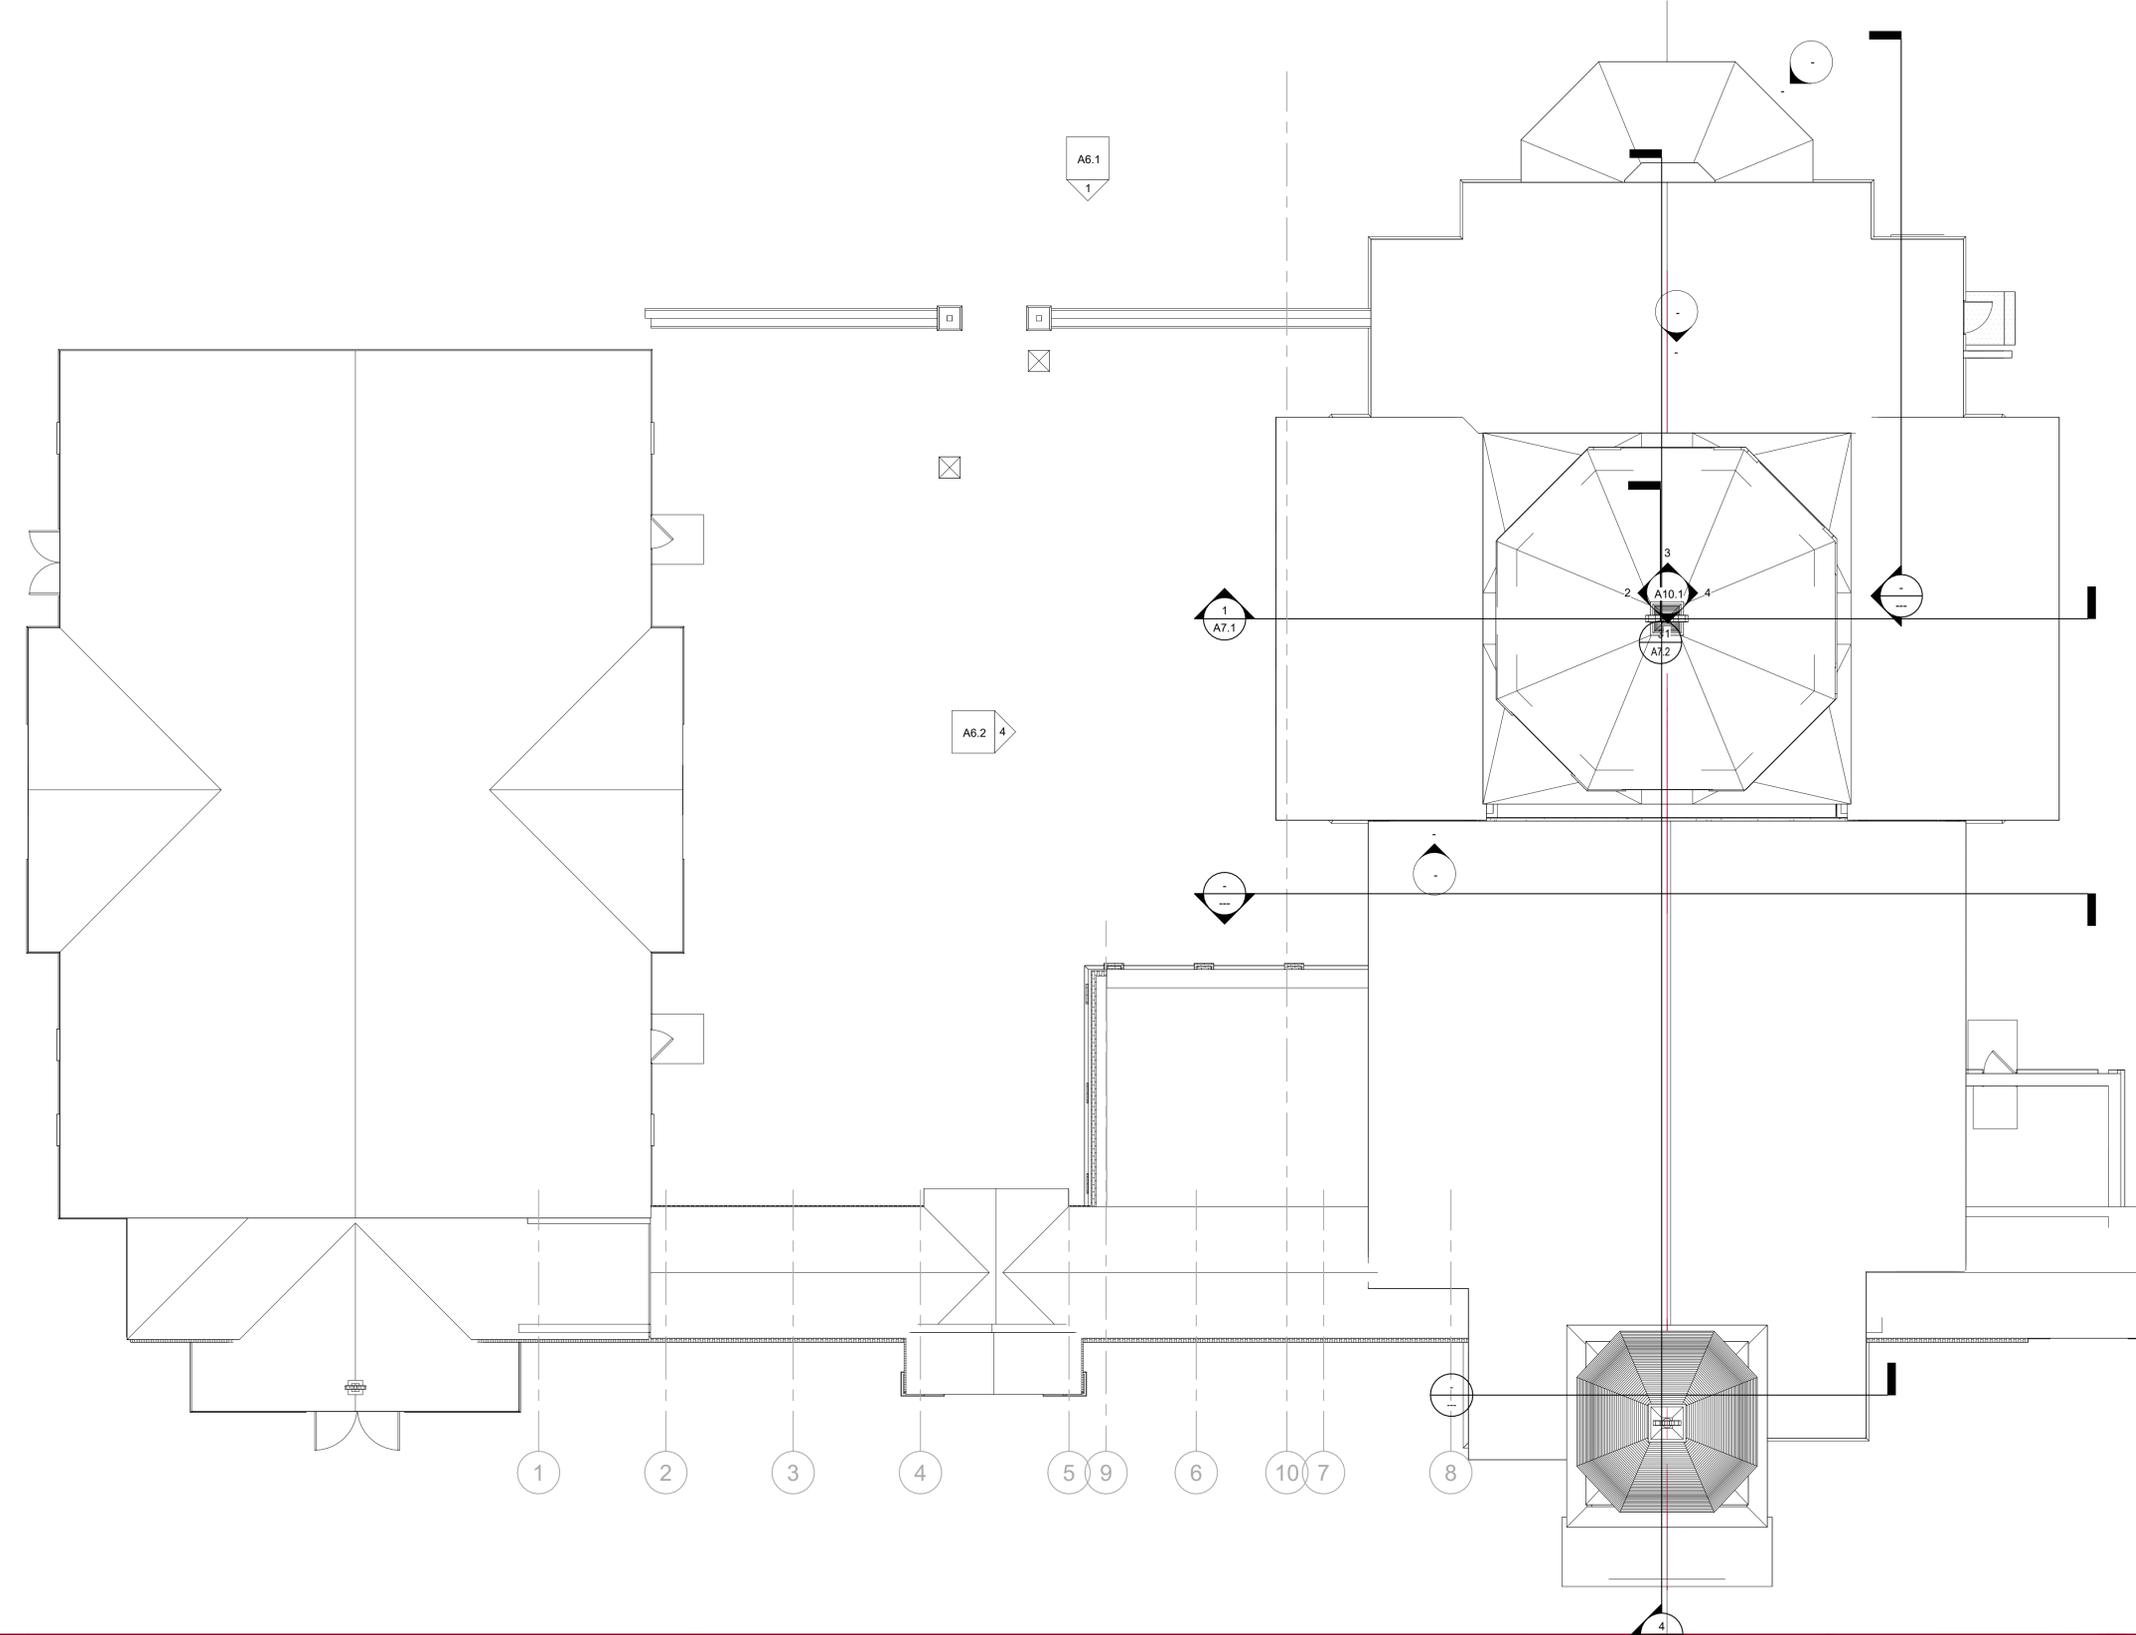
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### GENERAL NOTES - ROOF PLAN

- REFER TO SECTION 07000 OF THE PROJECT MANUAL FOR ROOF SYSTEM REQUIREMENTS.
- INSTALL ROOF SYSTEM COMPONENTS IN STRICT ACCORDANCE MANUFACTURER'S REQUIREMENTS.
- ALL COMPONENTS INTENDED FOR USE IN THE ROOF SYSTEM SHALL BE APPROVED BY MEMBRANE MANUFACTURER.
- CRICKETS & SADDLES - WHERE INDICATED PROVIDE TAPERED, FACTORY-CUT, PRE PACKAGED ASSEMBLIES OF SAME MATERIAL AS UNDERLYING INSULATION. PROVIDE SLOPES REQUIRED LIMITING PONDING OF WATER TO NO MORE THAN 24 HOURS.
- BITUMENADHESIVE ENVELOPES AND/OR METAL STOPS ARE REQUIRED AT ALL PERIMETERS AND ROOF PENETRATIONS. DO NOT ALLOW ROOFING WORK TO STAIN ROOF TOP PIPE, CONDUIT, BUILDING STRUCTURE, AND/OR BUILDING ENVELOPE. DO NOT ALLOW ROOFING DEBRIS TO ENTER DRAIN SYSTEM.
- INSPECT ROOF AND VERIFY UNRESTRICTED DRAINAGE EACH DAY AND END OF WORK.
- VERIFY ALL EXISTING CONDITIONS AND DIMENSIONS OF ROOF AREAS, LOCATIONS OF ROOFTOP EQUIPMENT, AND INCIDENTAL ITEMS OF WORK. THE DRAWINGS ARE DIAGRAMMATIC AND INDICATED DESIGN INTENT AND NOT EXACT QUANTITIES.
- THE ABSENCE OF INCREMENTAL ITEMS OF WORK ON THE CONTRACT DOCUMENTS DOES NOT ALLEVIATE THE CONTRACTOR OF RESPONSIBILITY OF PROVIDING ALL WORK REQUIRED TO PROPERLY ROOF, FLASH, AND MAKE WATERPROOF ALL ITEMS THAT CAN BE REASONABLY INFERRED AS BEING PART OF THE WORK.
- REFER TO MANUFACTURER'S RECOMMENDED DETAILS OR NRCA STANDARD DETAILS, WHICH EVER IS MOST STRINGENT, FOR CONDITIONS NOT DETAILED.
- ROOFING MATERIALS BOTH STORED AND IN PLACE SHALL BE PROTECTED FROM WEATHER INCLUDING WIND AND MOISTURE. PROVIDE CUT OFFS ETC AT THE END OF EACH DAYS WORK. WET OR OTHERWISE COMPROMISED ROOF MATERIALS SHALL BE REMOVED FROM THE SITE AND REPLACED AT CONTRACTORS EXPENSE.
- ROOF SLOPES SHOWN ON THE CONTRACT DOCUMENTS INDICATED DESIGN INTENT. PROVIDE ROOF SLOPES REQUIRED LIMITING PONDING OF WATER TO NO MORE THAN 24 HOURS.
- METAL FLASHINGS - PROVIDE CONCEALED (INTERNAL) SPLICE PLATES TYPICAL AT ALL METAL FLASHINGS AND COPINGS EXPOSED TO PUBLIC VIEW.
- AT PERIMETER OF ALL ROOF PROVIDE FACTORY FABRICATED, CONTINUOUS 24" WIDE TAPERED PERLITE EDGE STRIP BETWEEN THERMAL INSULATION AND RETRO BOARD. PROVIDE MIN. 1/2" FOOT SLOPE.
- AT ALL ROOF TOP EQUIPMENT PROVIDE FACTORY PAINTED FINISH AT EXPOSED SURFACES. WHERE FACTORY FINISH IS NOT AVAILABLE FIELD PAINT IN COLOR AS SELECTED BY ARCHITECT. SUMP 48" X 48" TYPICAL AT EA DRAIN.

### ROOF PLAN SYMBOLS:

	2 A6.1 ↑	+3" TAPERED INSULATION	DIMENSION INDICATES HEIGHT OF ABOVE STRUCTURAL DECK
	↑		DIRECTION OF "DOWNHILL" SLOPE
	OD		OVERFLOW ROOF DRAIN
	RD		ROOF DRAIN
	DS		DOWN SPOUT
	SC		SCUPPER
			ROOF SLOPE-PEAKS AND VALLEYS



**1** ROOF PLAN  
SCALE: 1/8" = 1'-0"

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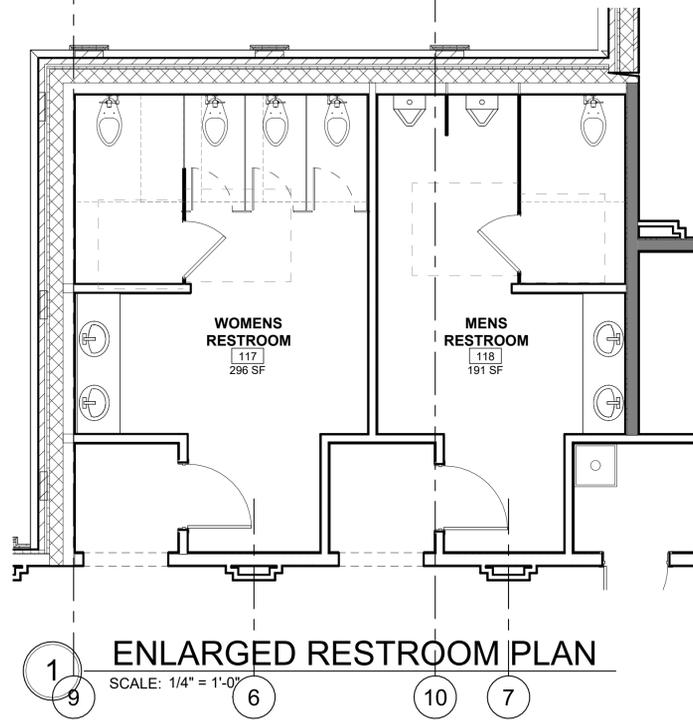
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**A4.1**

ROOF PLAN

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**A5.1**

ENLARGED PLANS

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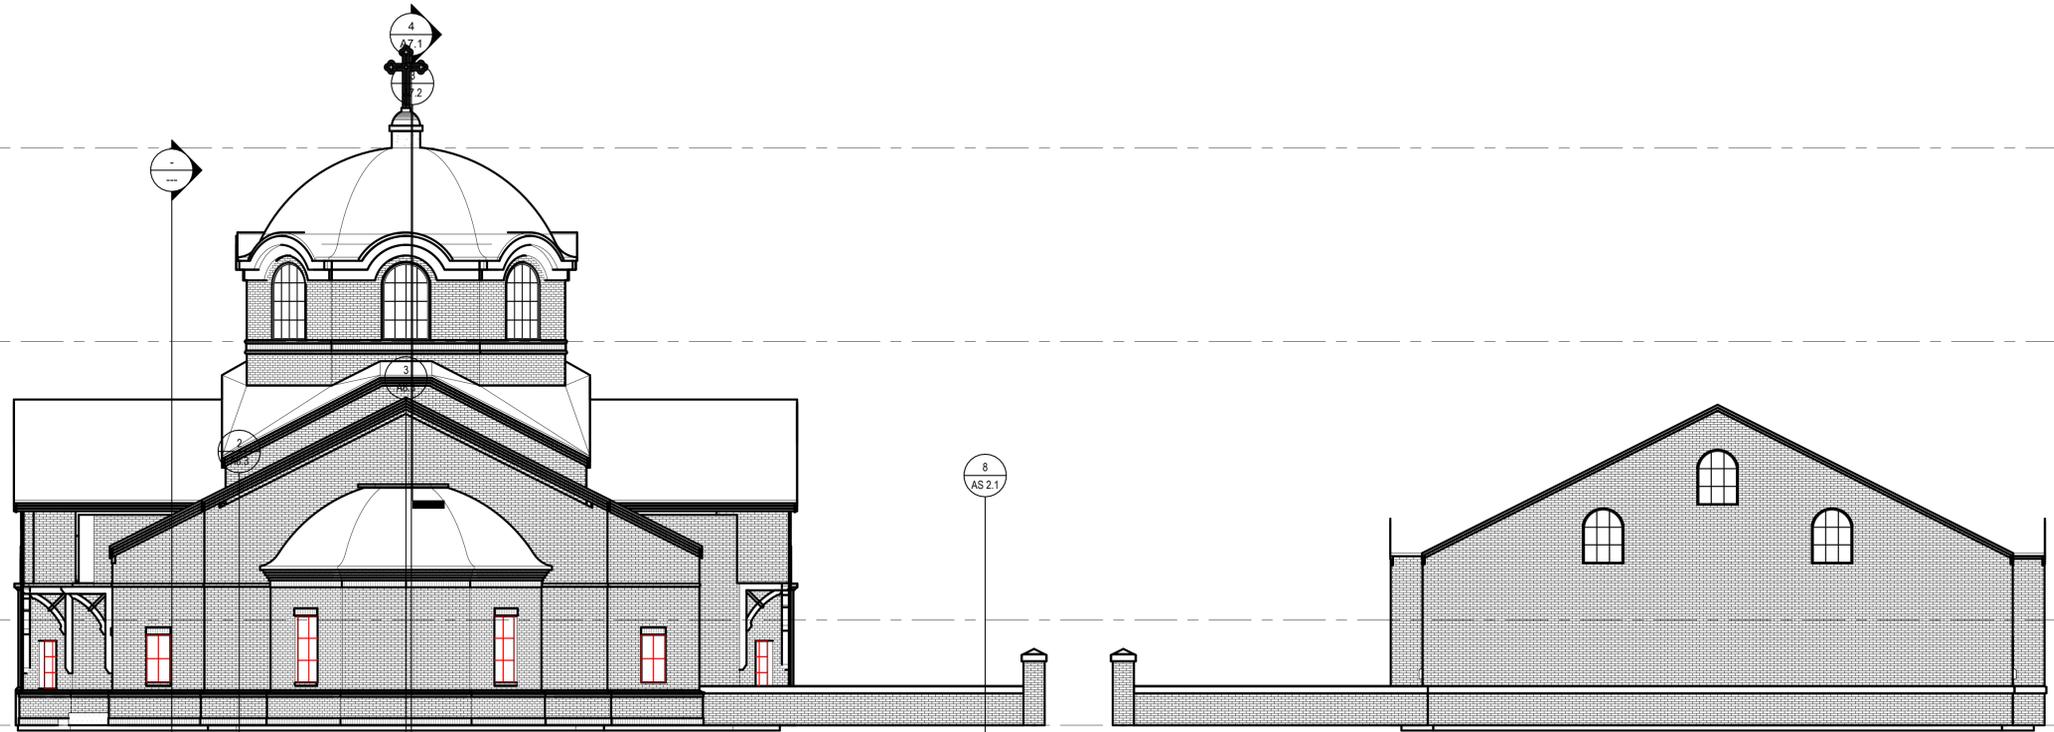
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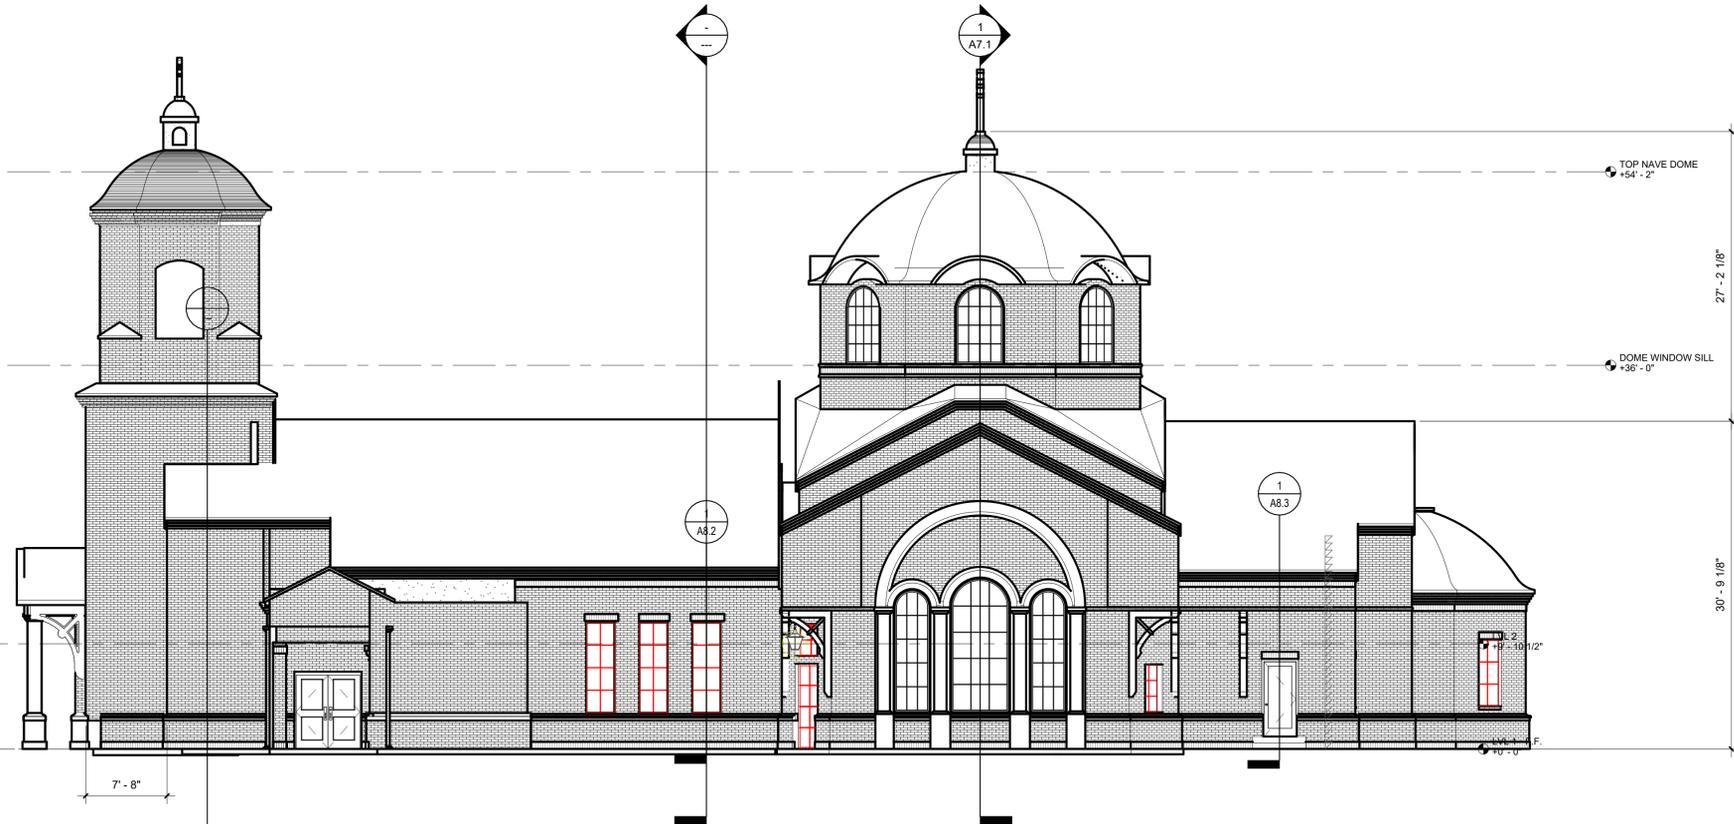
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EXTERIOR ELEVATIONS

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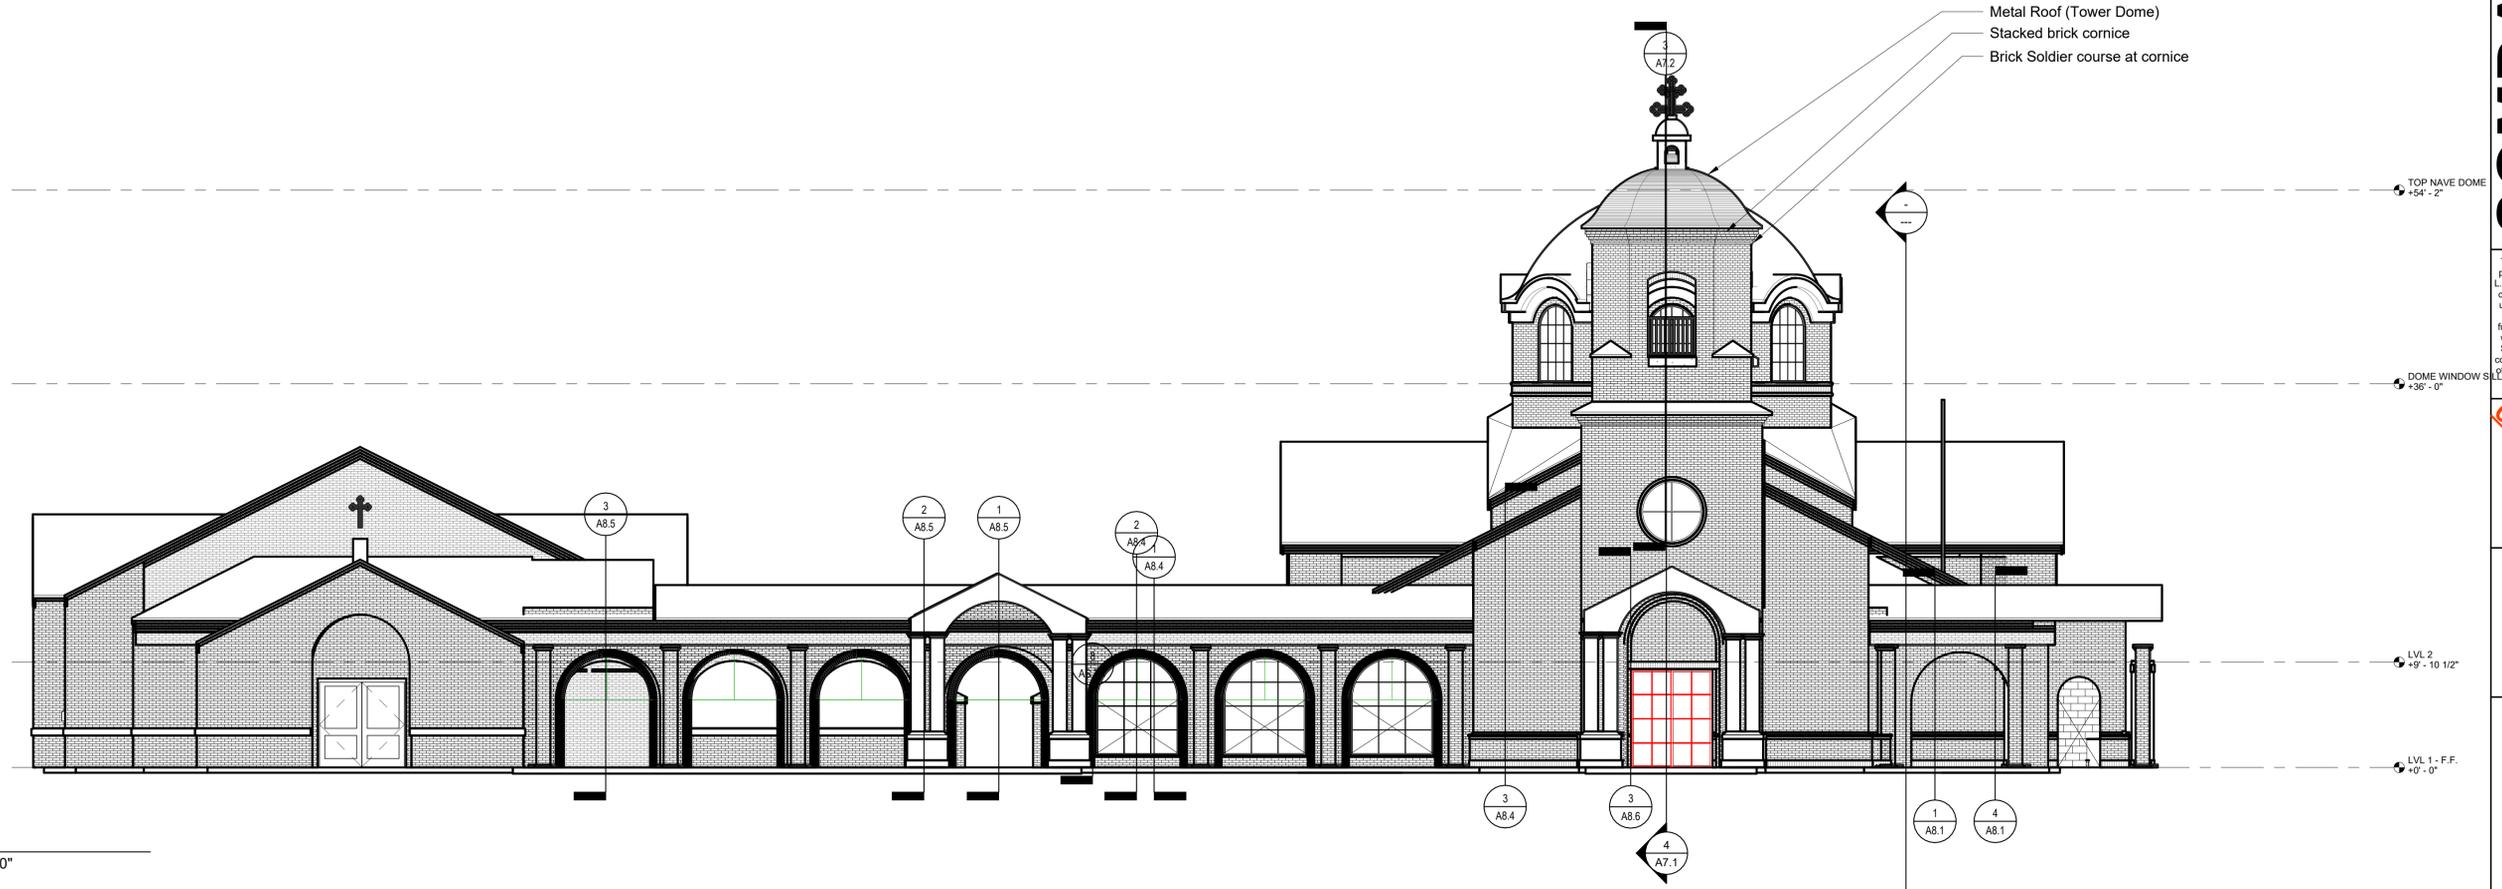


**1 North**  
SCALE: 1/8" = 1'-0"




**2 East**  
SCALE: 1/8" = 1'-0"

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**3** South  
SCALE: 1/8" = 1'-0"



**4** West  
SCALE: 1/8" = 1'-0"
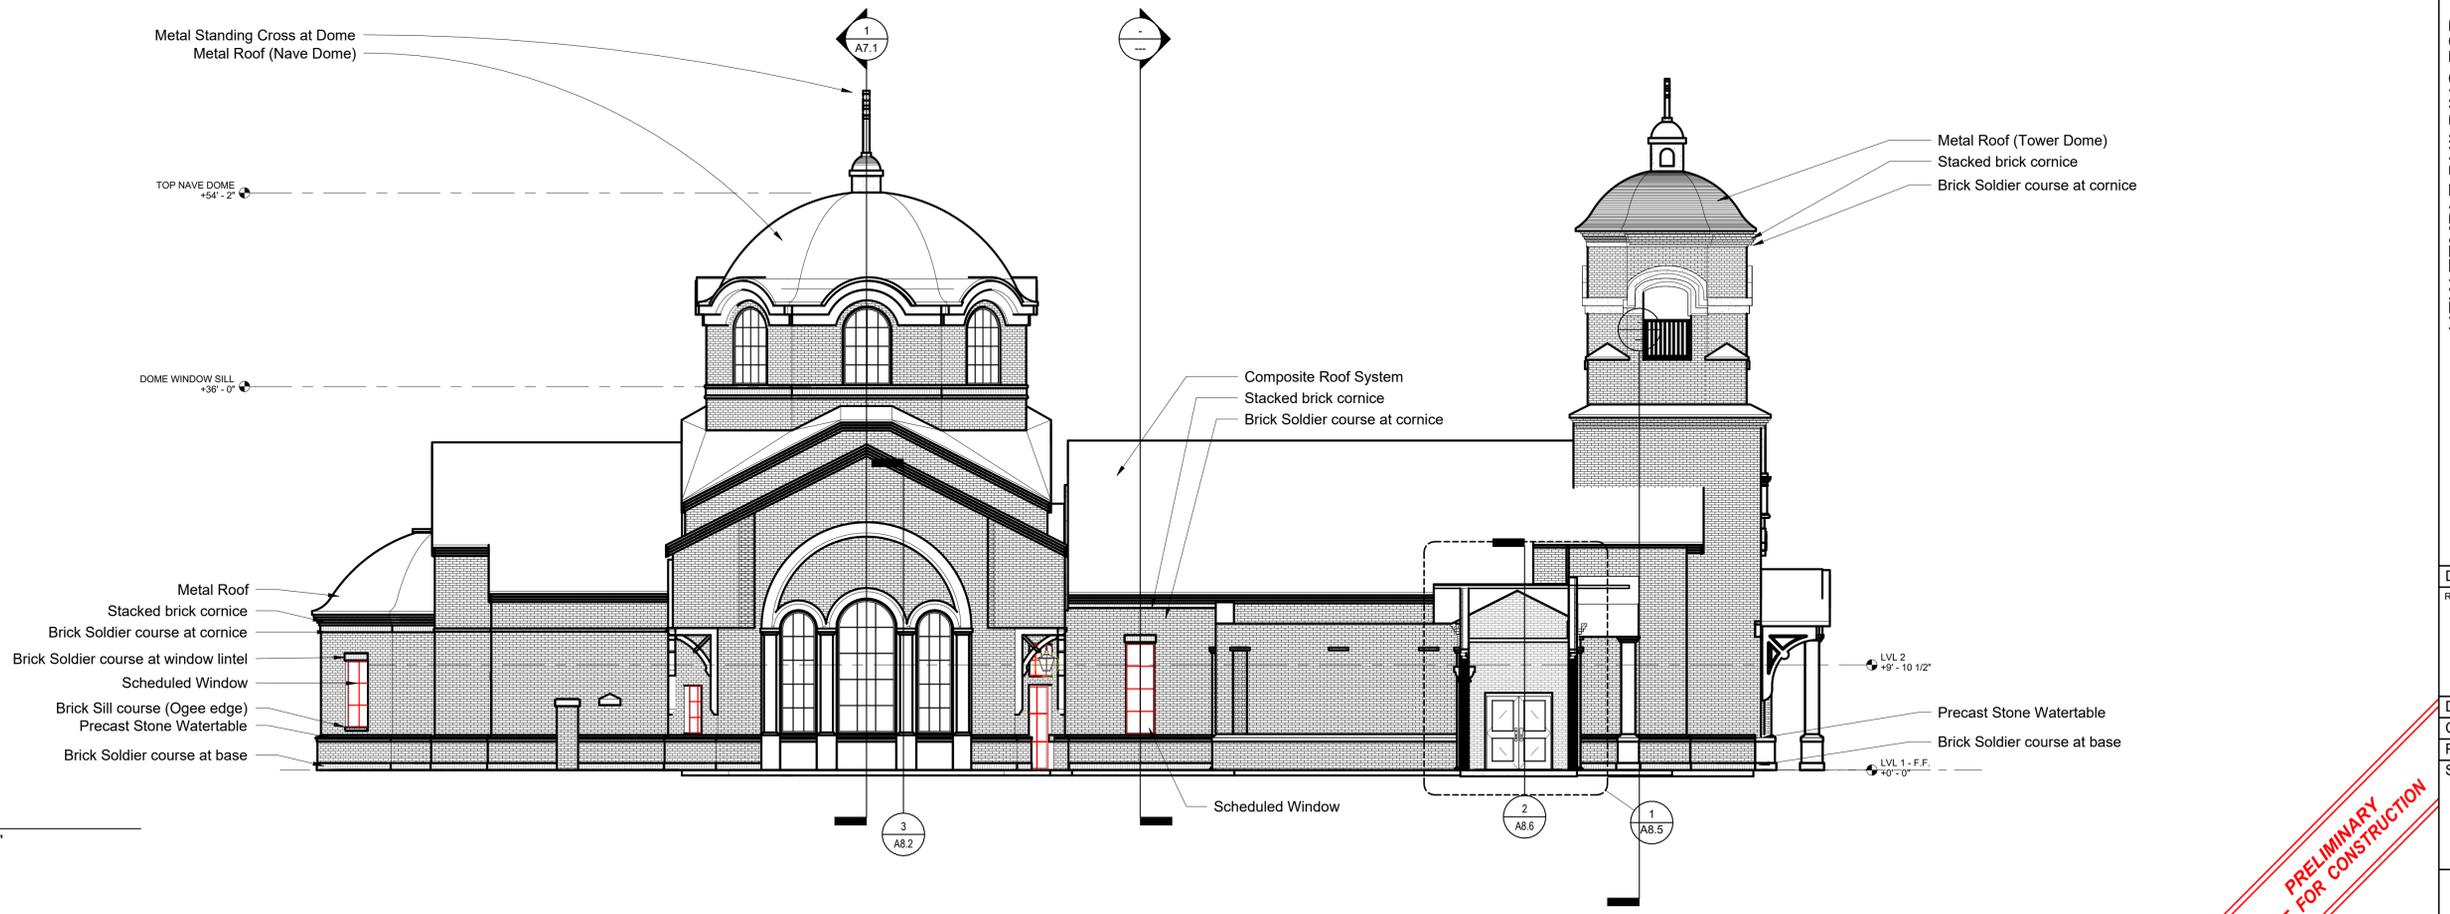
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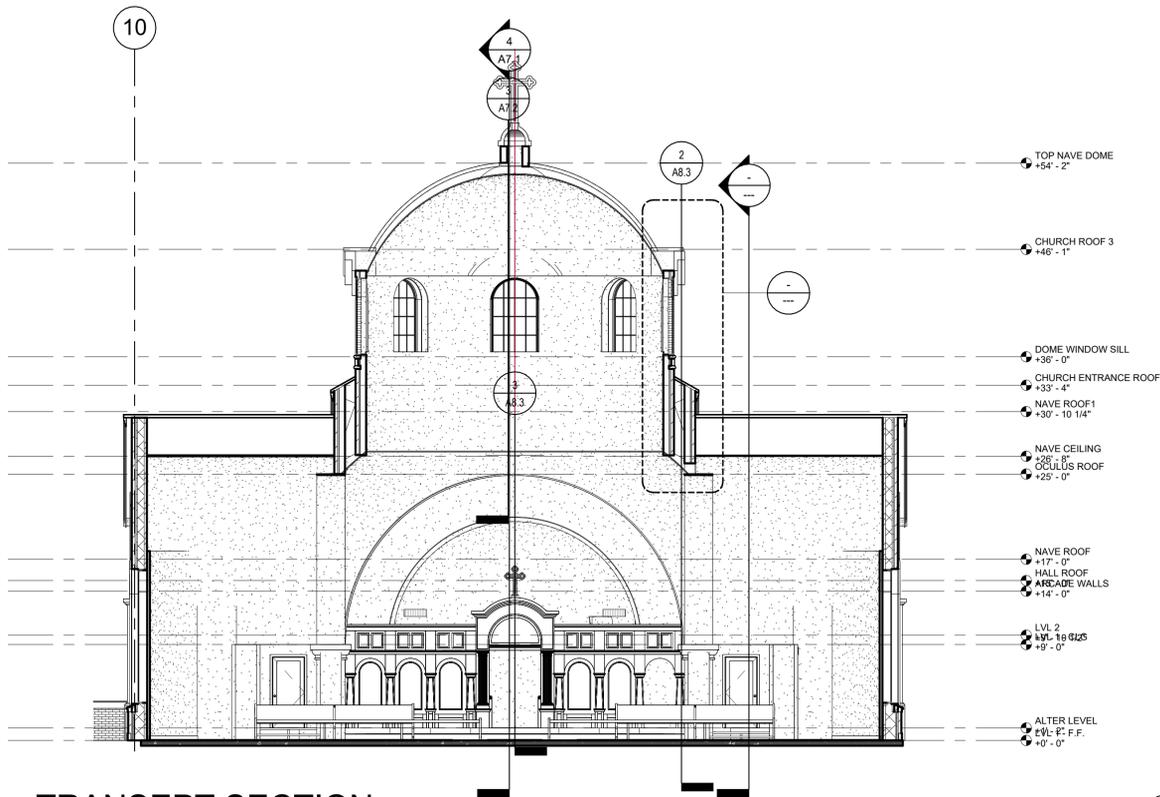
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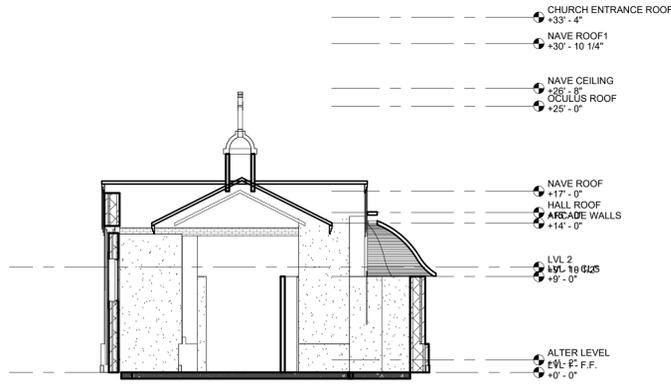
EXTERIOR ELEVATIONS

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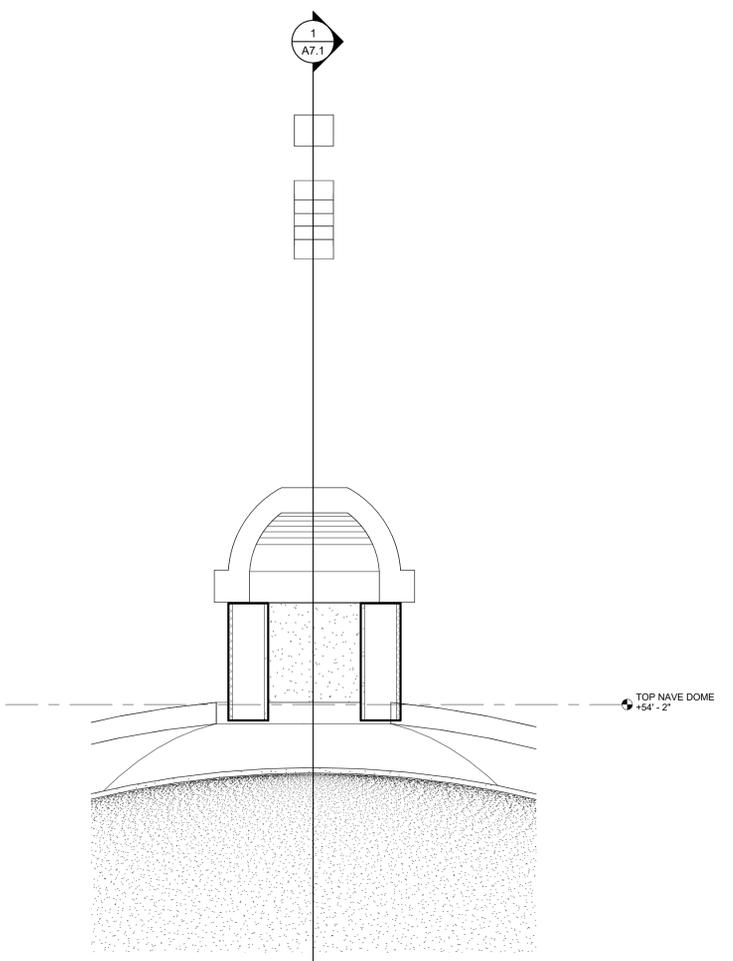
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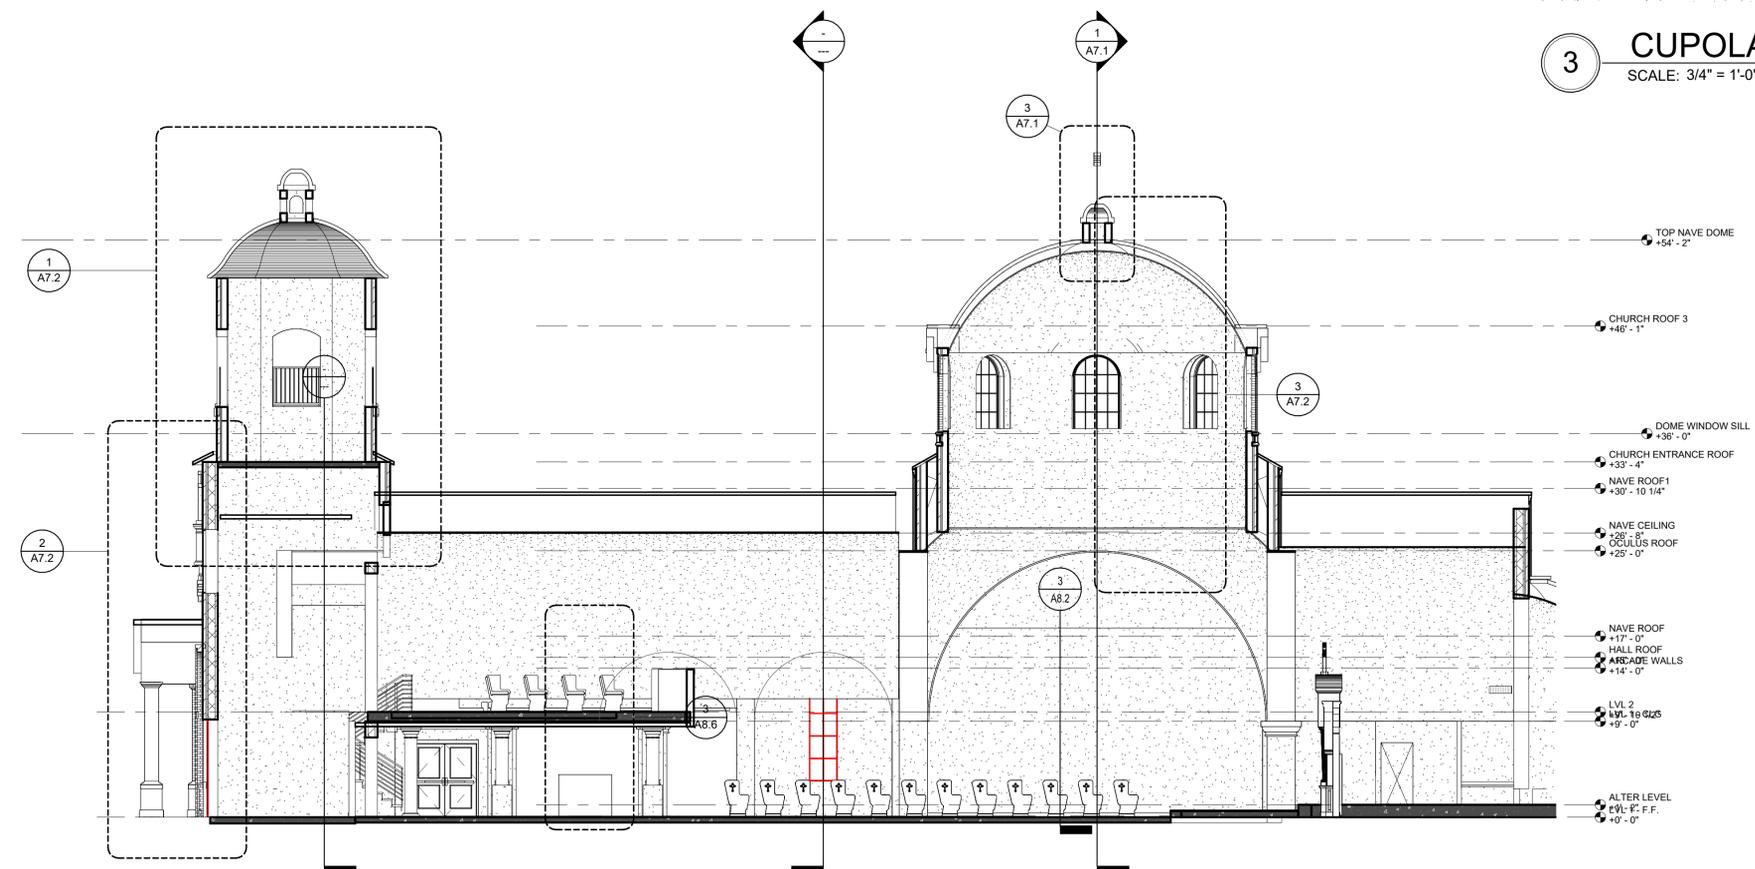
**1** TRANSEPT SECTION  
SCALE: 1/8" = 1'-0"



**2** BAPTISMAL SECTION  
SCALE: 1/8" = 1'-0"



**3** CUPOLA  
SCALE: 3/4" = 1'-0"



**4** NAVE SECTION  
SCALE: 1/8" = 1'-0"

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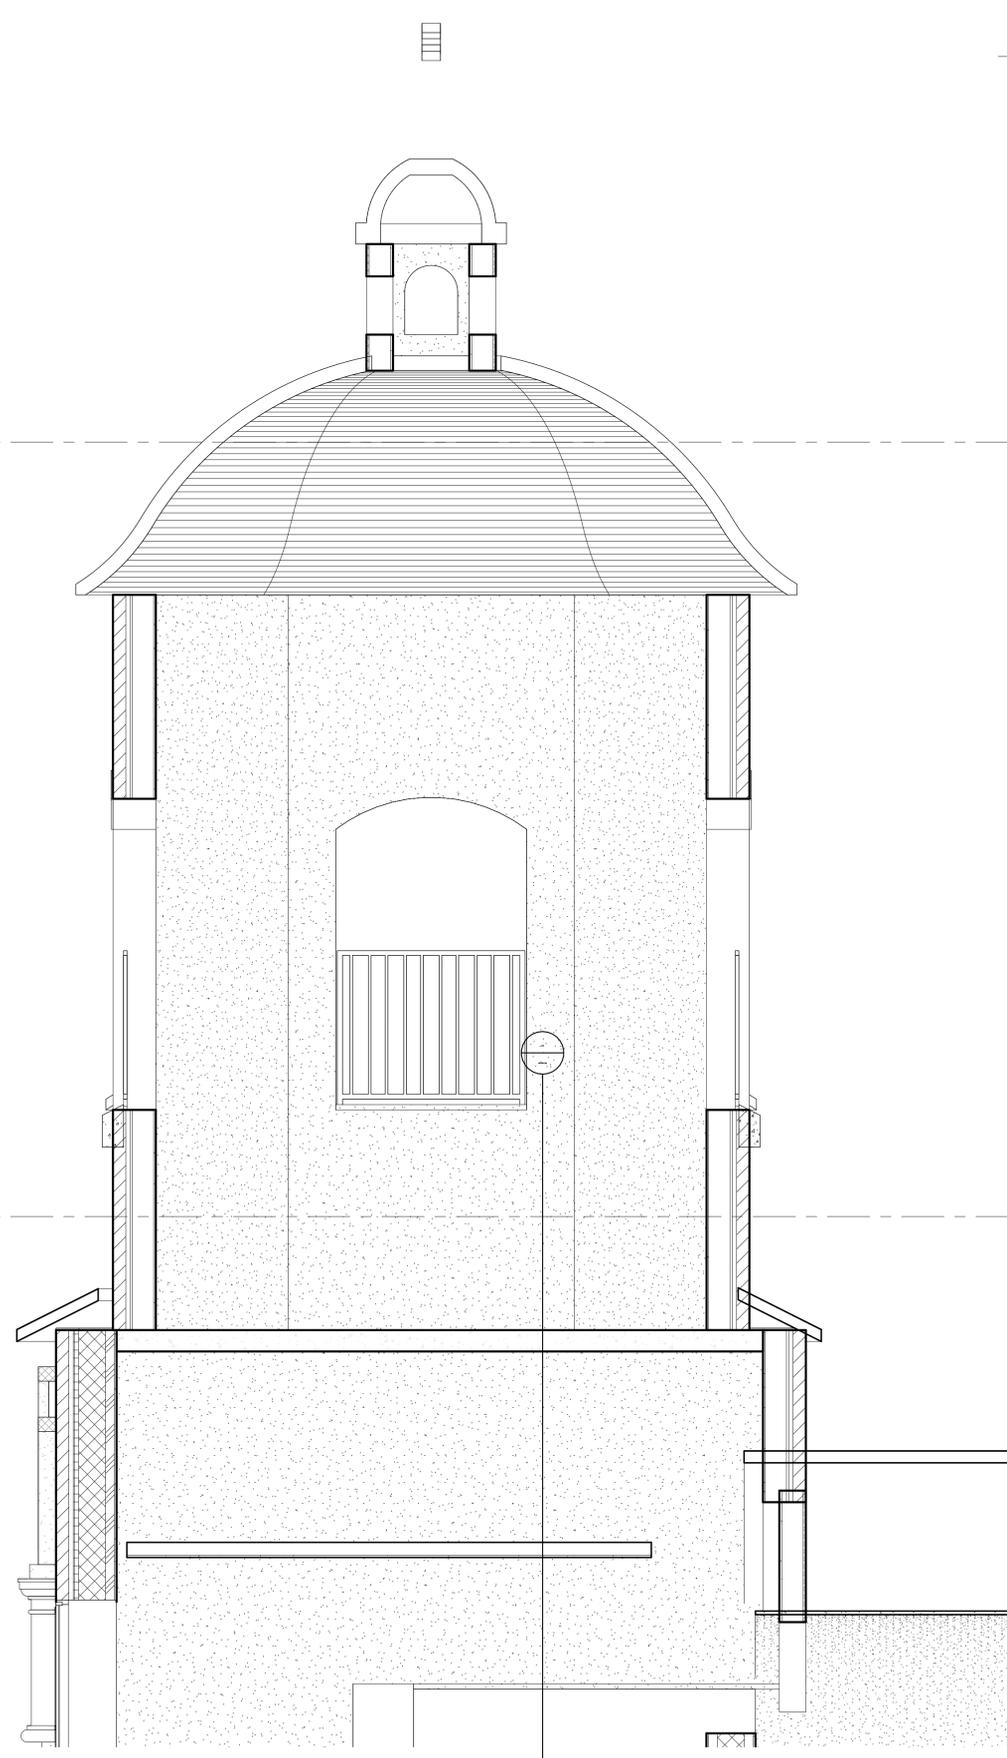
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BUILDING SECTIONS


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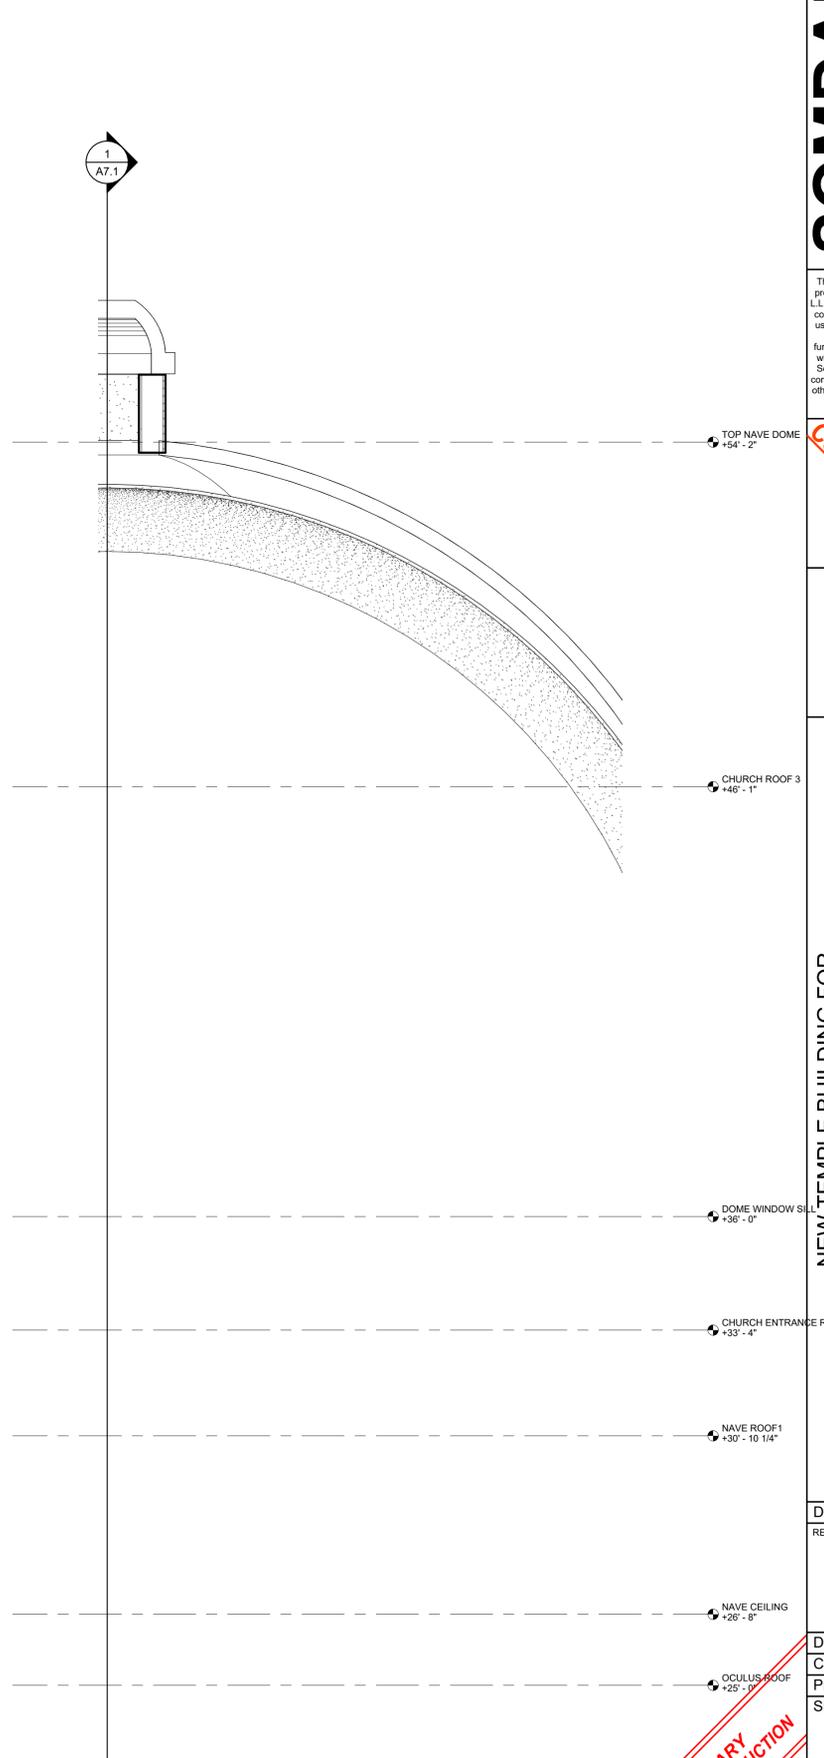
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**1** VESTIBULE TOWER TOP  
SCALE: 1/2" = 1'-0"



**2** VESTIBULE TOWER BASE  
SCALE: 1/2" = 1'-0"



**3** MAIN DOME SECTION  
SCALE: 1/2" = 1'-0"
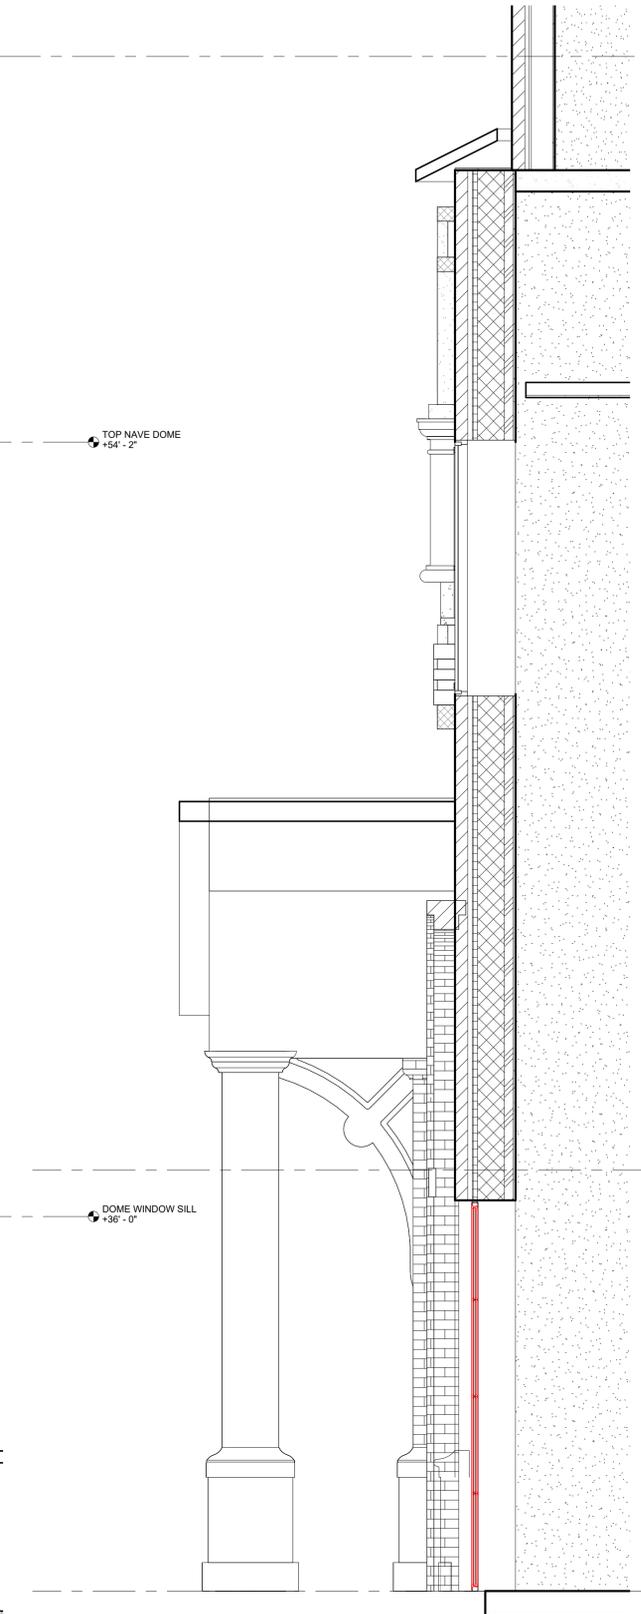
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**A7.2**

BUILDING SECTIONS

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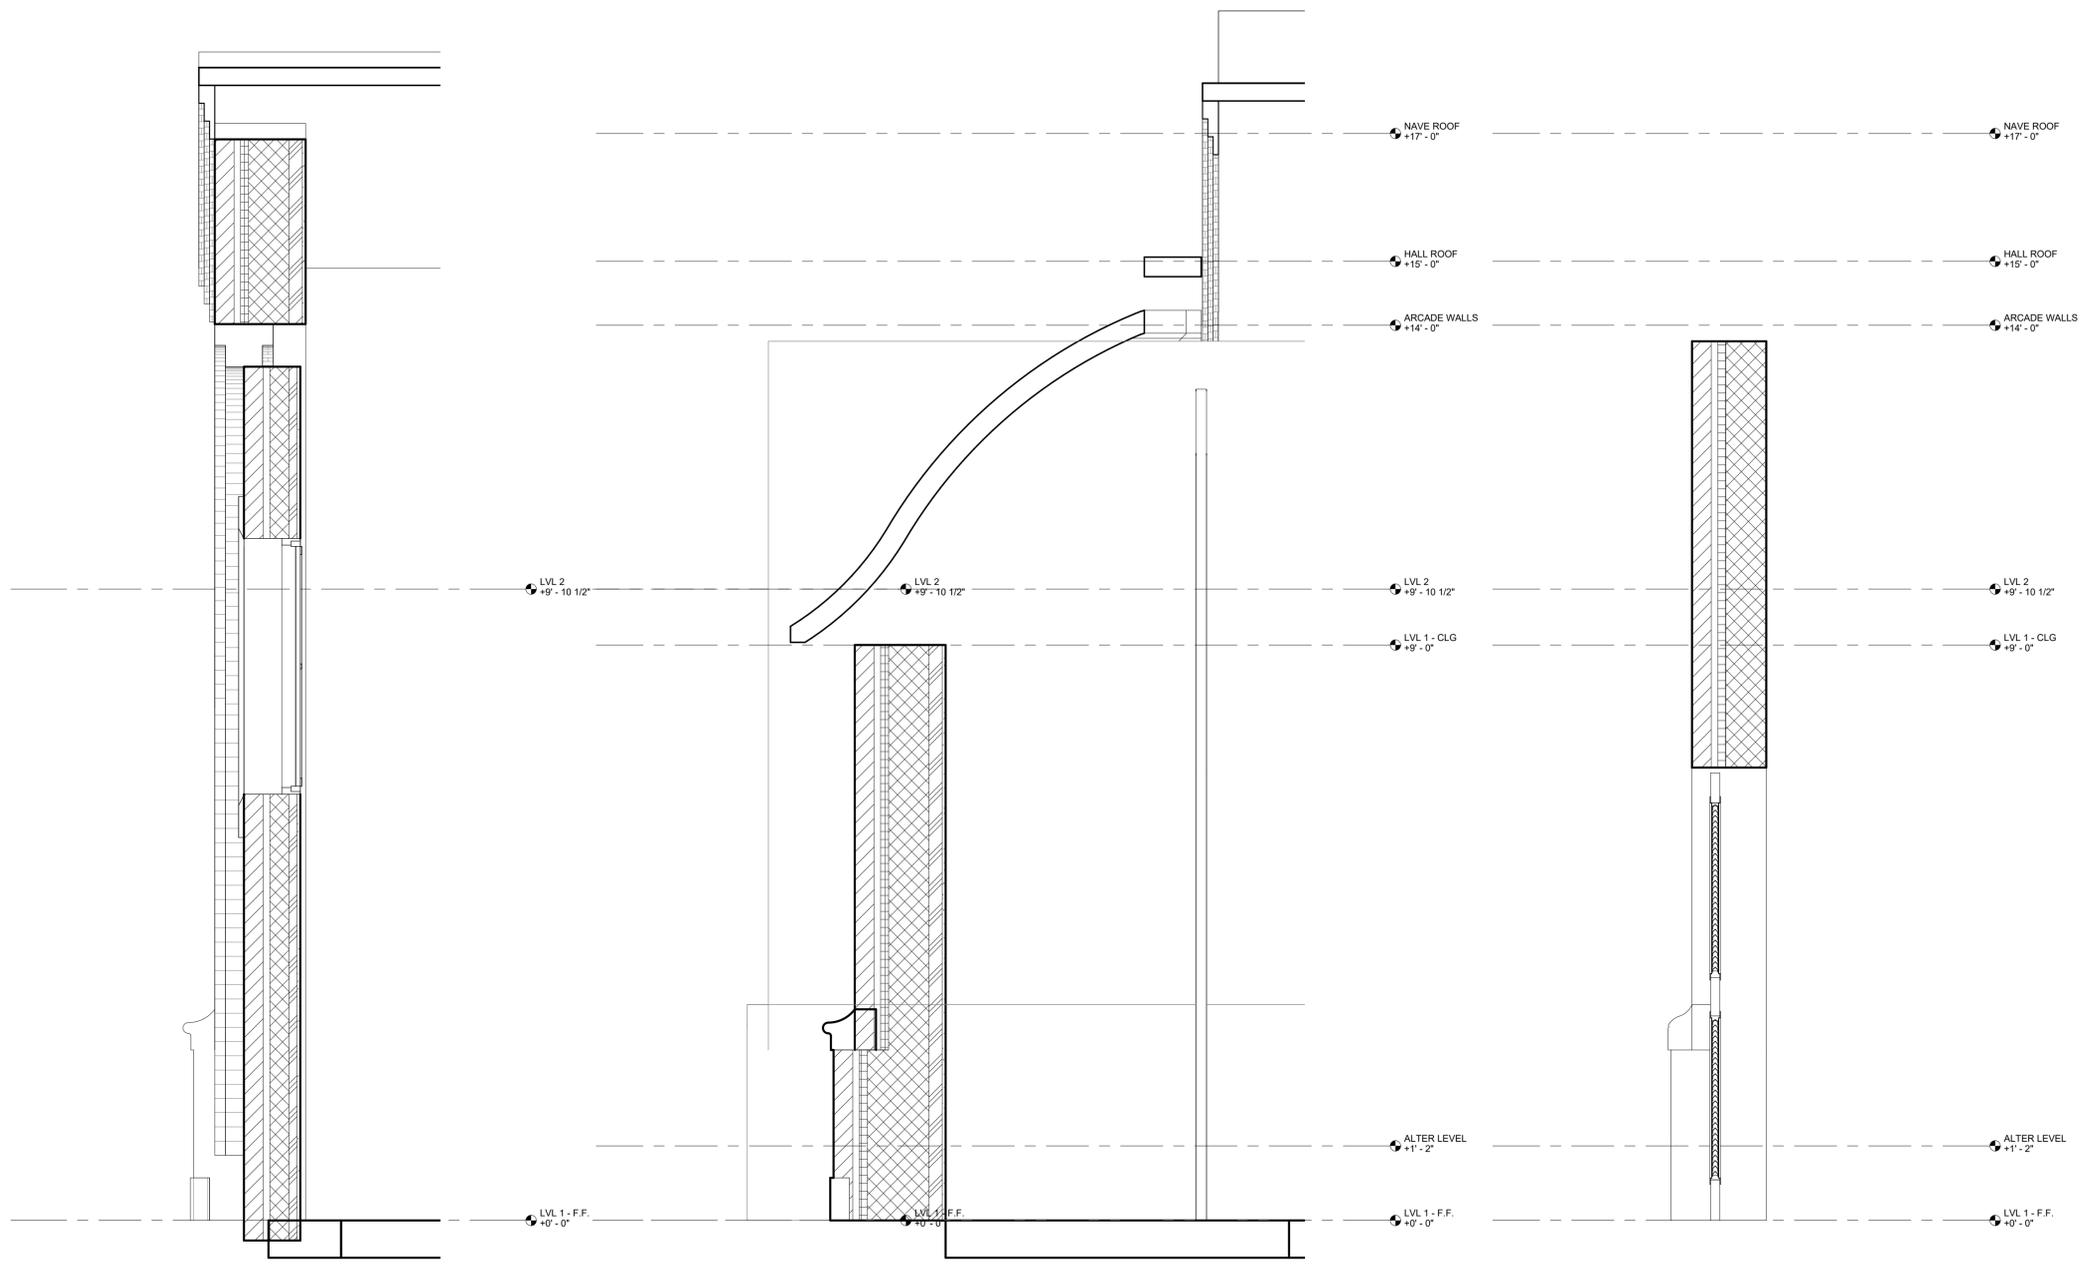
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1 WALL SECTION  
SCALE: 3/4" = 1'-0"

2 WALL SECTION  
SCALE: 3/4" = 1'-0"

3 BAPTISMAL DOME  
SCALE: 3/4" = 1'-0"

4 WALL SECTION  
SCALE: 3/4" = 1'-0"



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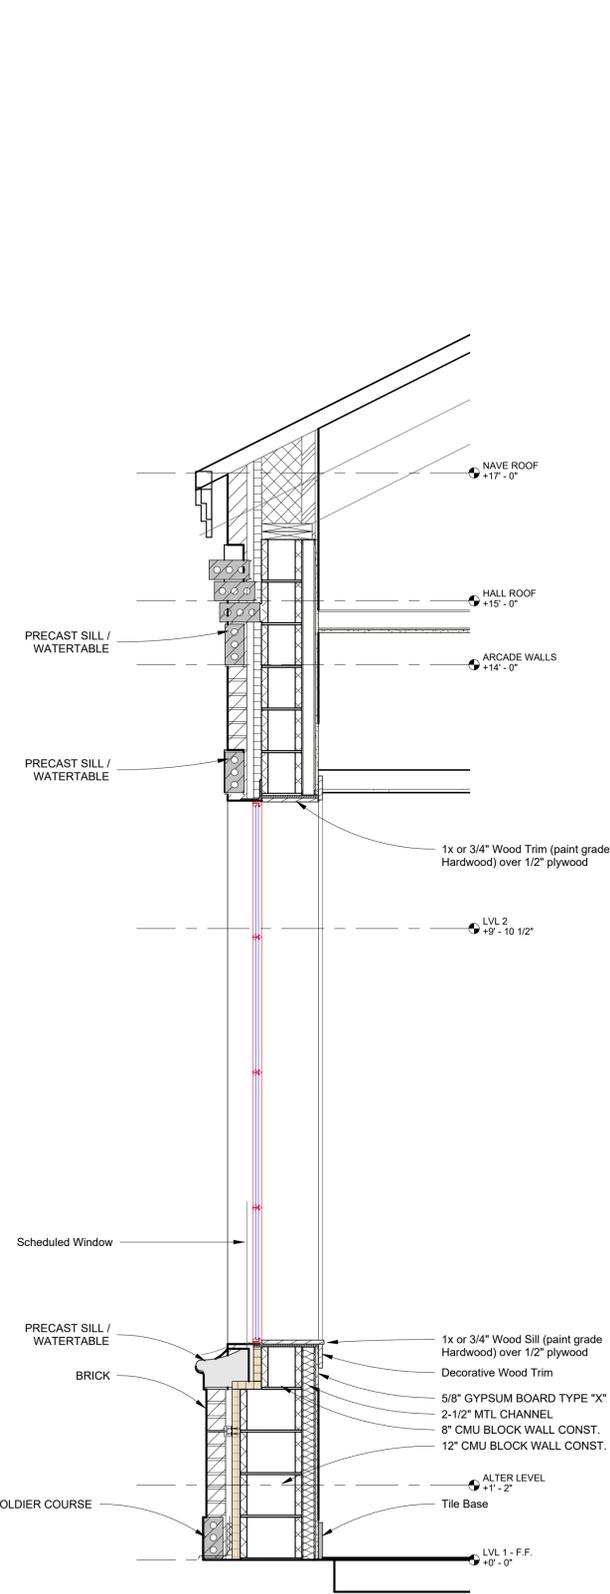
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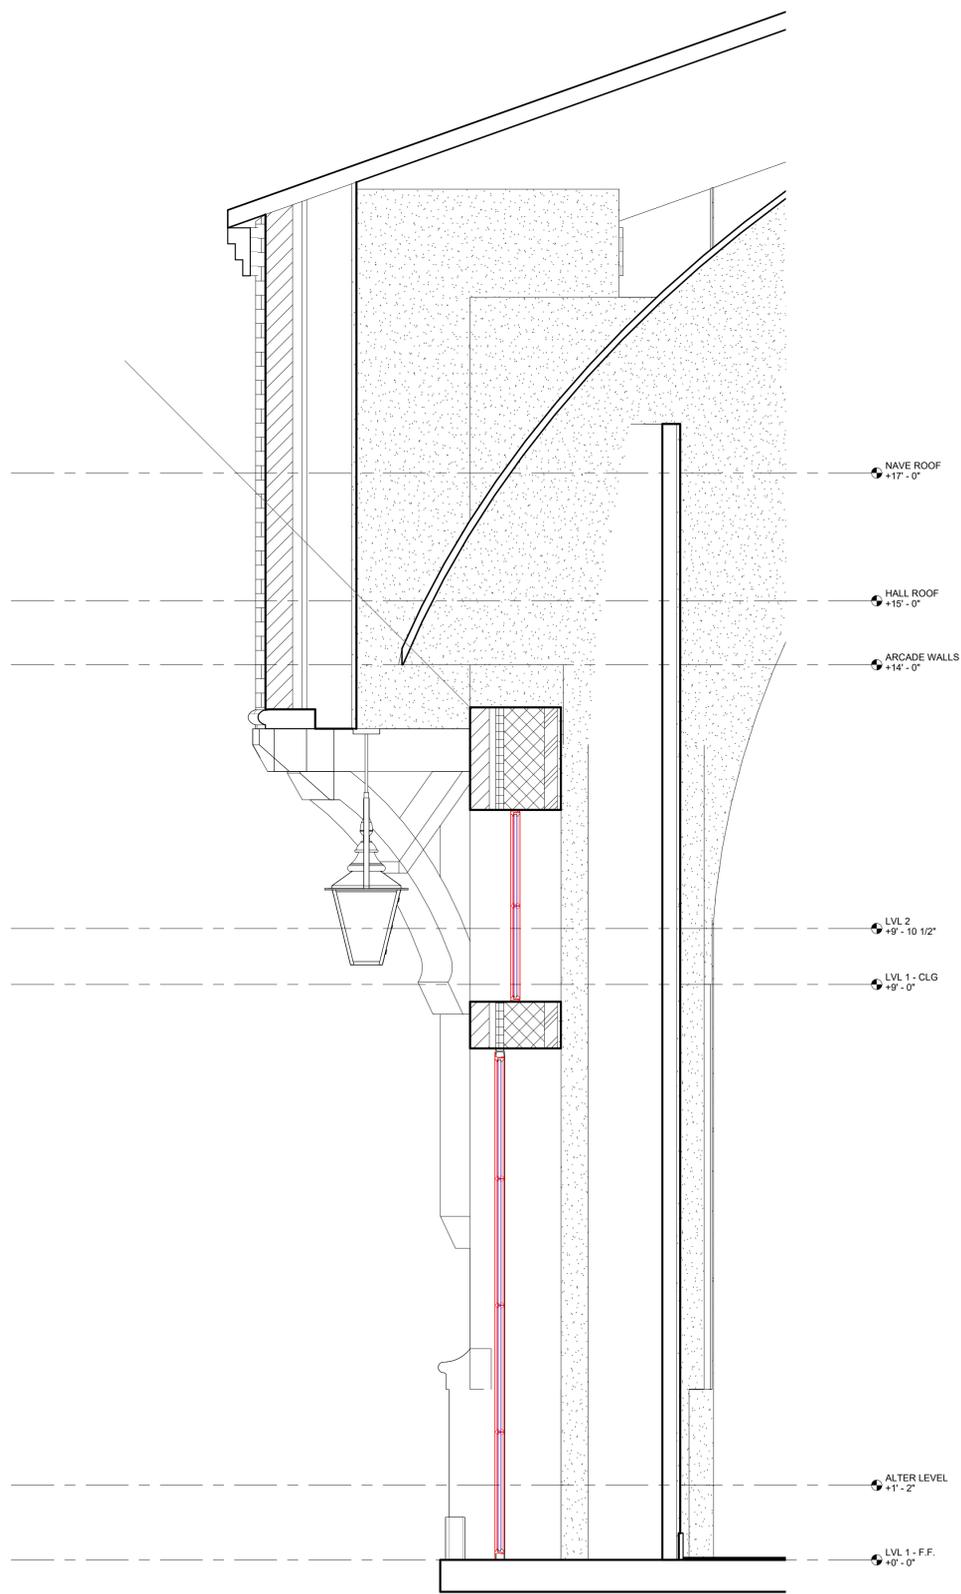
WALL SECTIONS

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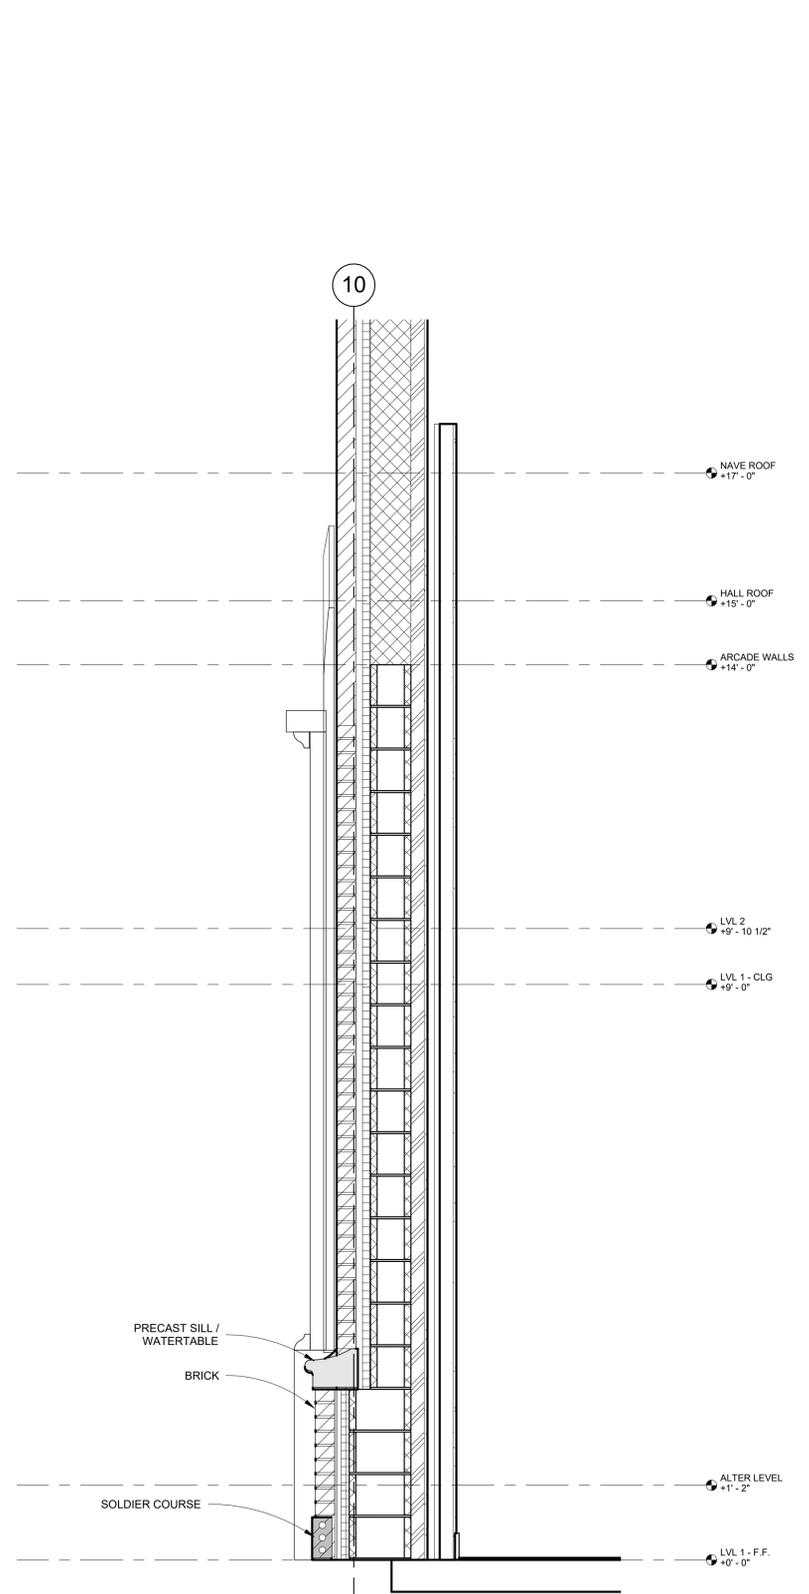
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**1** Typical Section at Nave Window  
SCALE: 3/4" = 1'-0"



**2** TRANSEPT EXIT  
SCALE: 3/4" = 1'-0"



**3** TRANSEPT WALL SECTION  
SCALE: 3/4" = 1'-0"

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CONSTRUCTION**

NEW TEMPLE BUILDING FOR  
**ST. NICHOLAS ORTHODOX CHURCH**  
9100 Youree Dr, Shreveport, LA 71115

Date: 10/31/2025  
REVISION DATE


Drawn by: LCM  
Checked by: Checker  
Project #: 2505  
Sheet:

**A8.2**

WALL SECTIONS

Autodesk Docs://2505 St. Nicholas Orthodox Church/2505 St. Nicholas\_R24.rvt

12/4/2025 11:44:27 AM

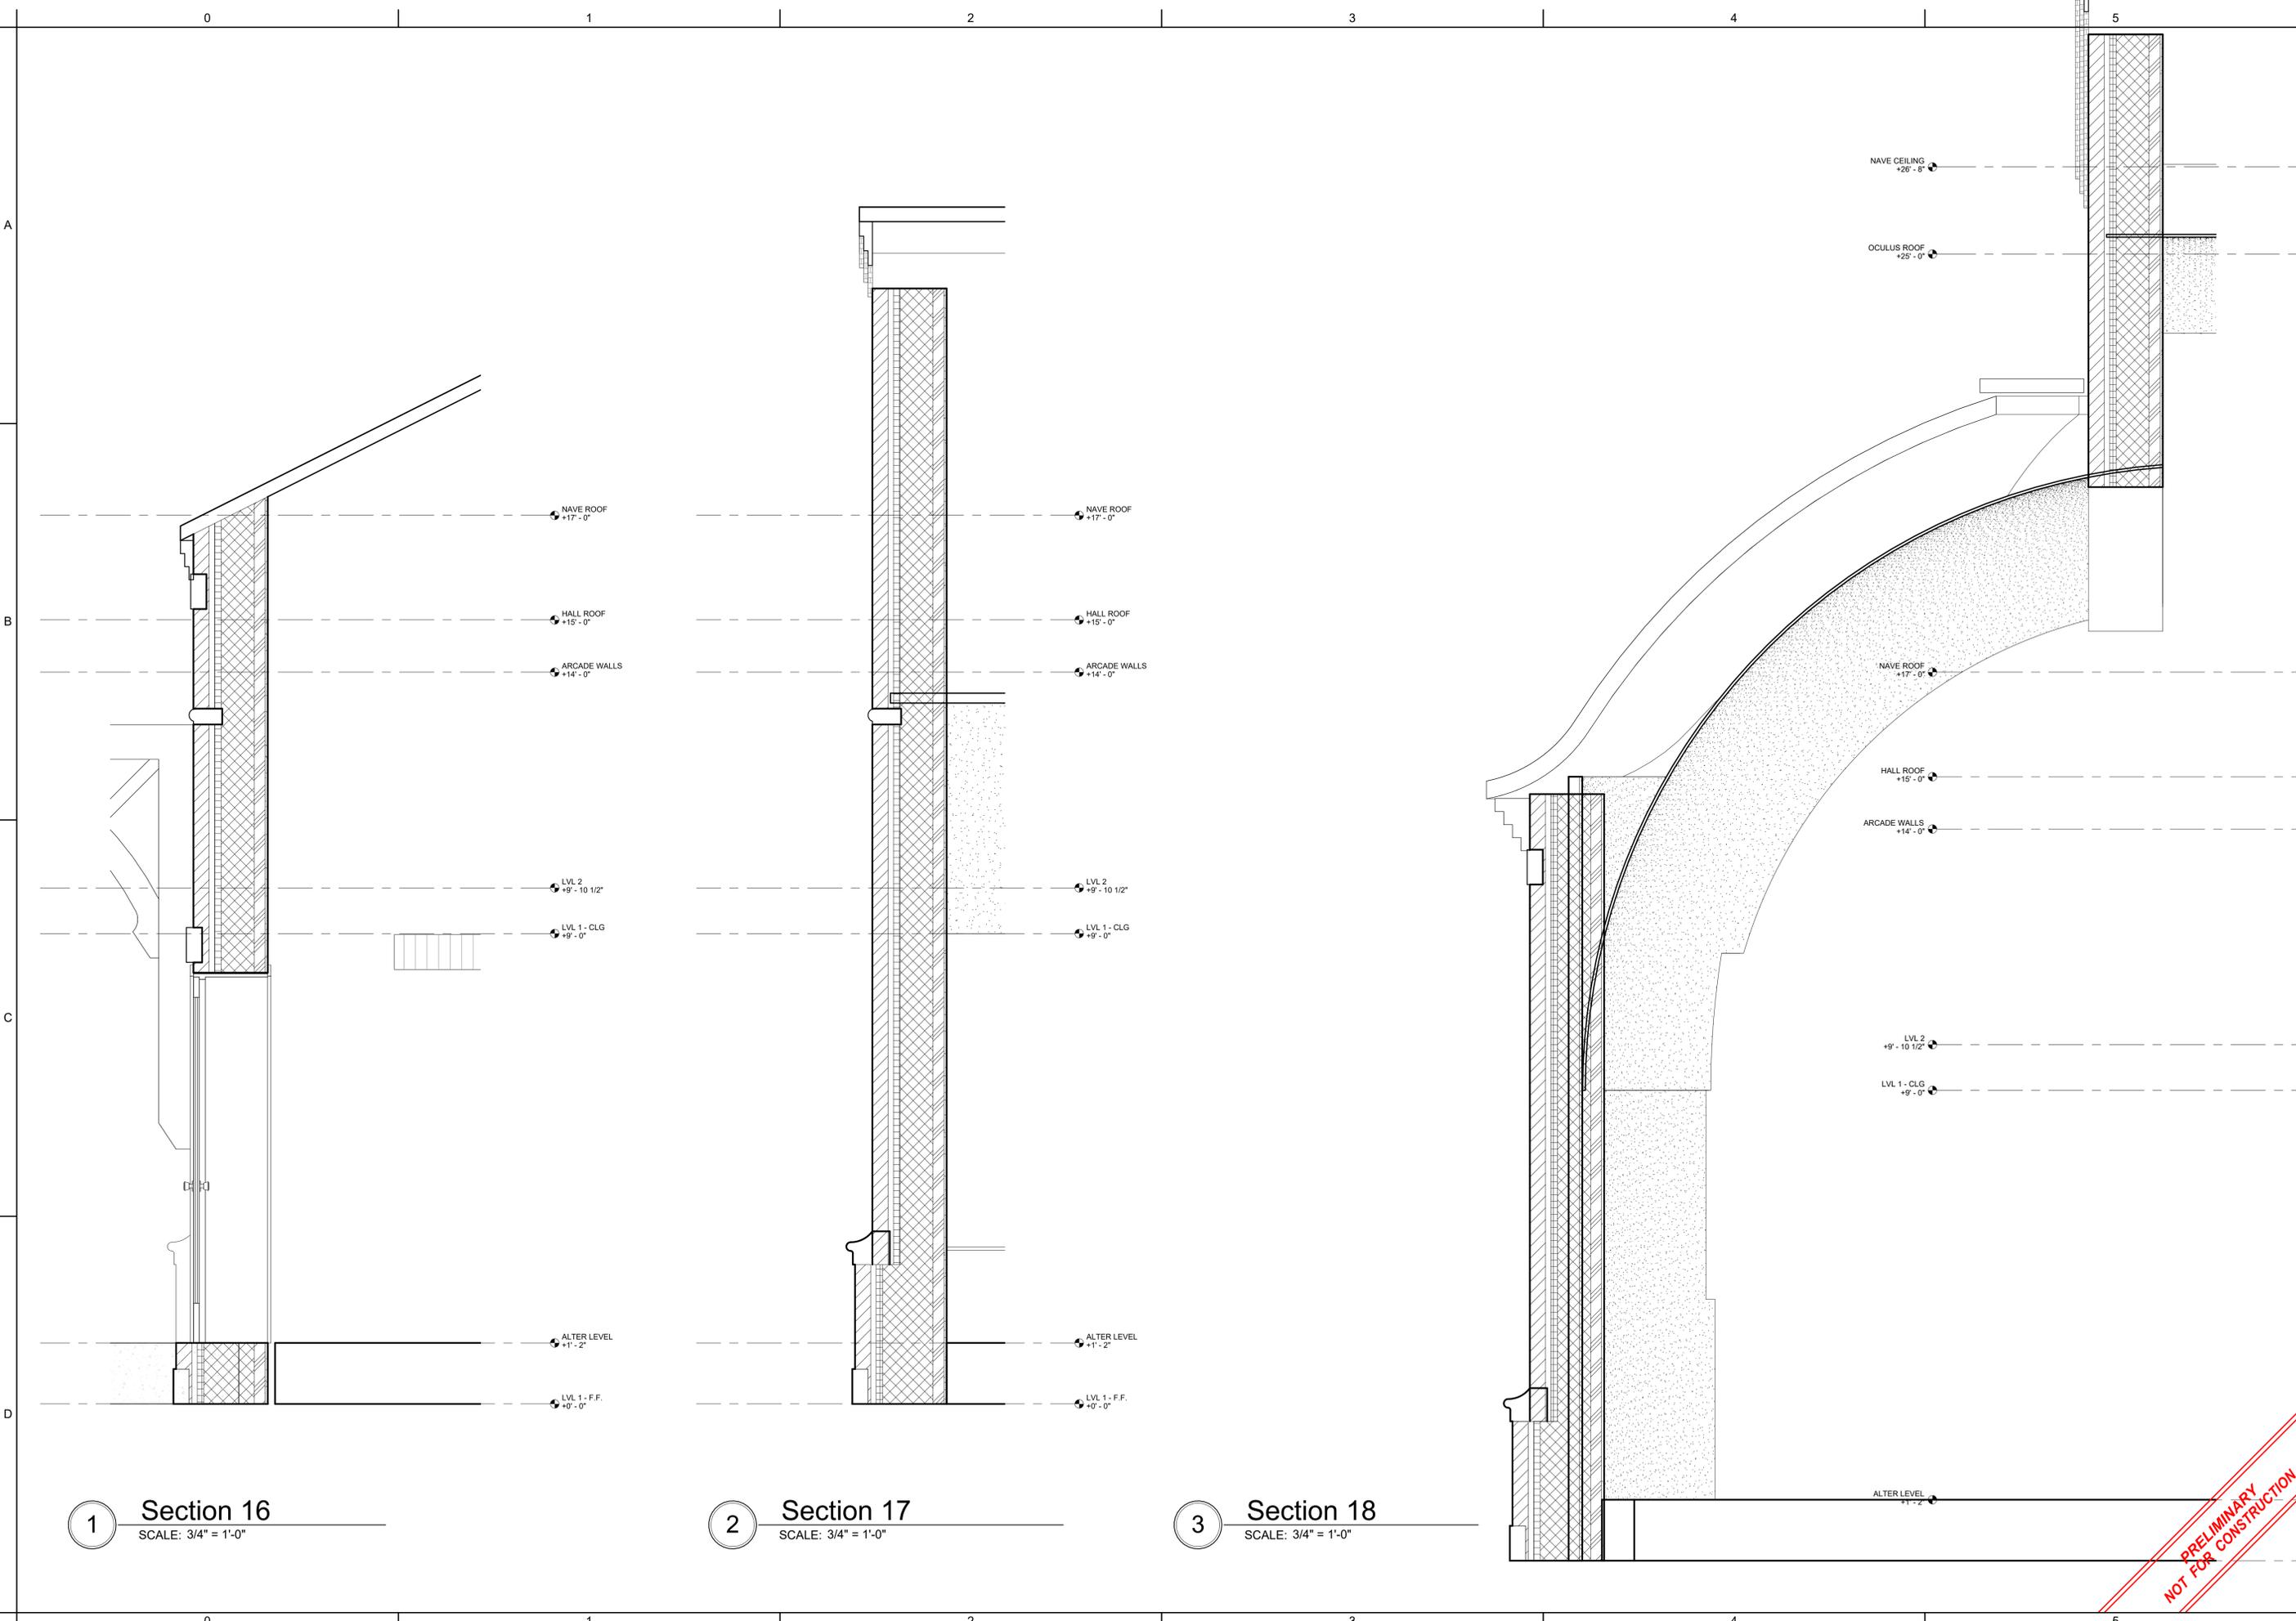

1 Section 16  
SCALE: 3/4" = 1'-0"

2 Section 17  
SCALE: 3/4" = 1'-0"

3 Section 18  
SCALE: 3/4" = 1'-0"

**SOMDAL ASSOCIATES**  
ARCHITECTURE + INTERIOR DESIGN  
333 TEXAS STREET, SUITE 1900 SHREVEPORT, LA 71101

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9100 Youree Dr, Shreveport, LA 71115

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Project #: 2505  
Sheet:


**A8.3**

WALL SECTIONS

**PRELIMINARY NOT FOR CONSTRUCTION**


Autodesk Docs://2505 St. Nicholas Orthodox Church/2505 St. Nicholas\_R24.rvt

12/4/2025 11:44:29 AM

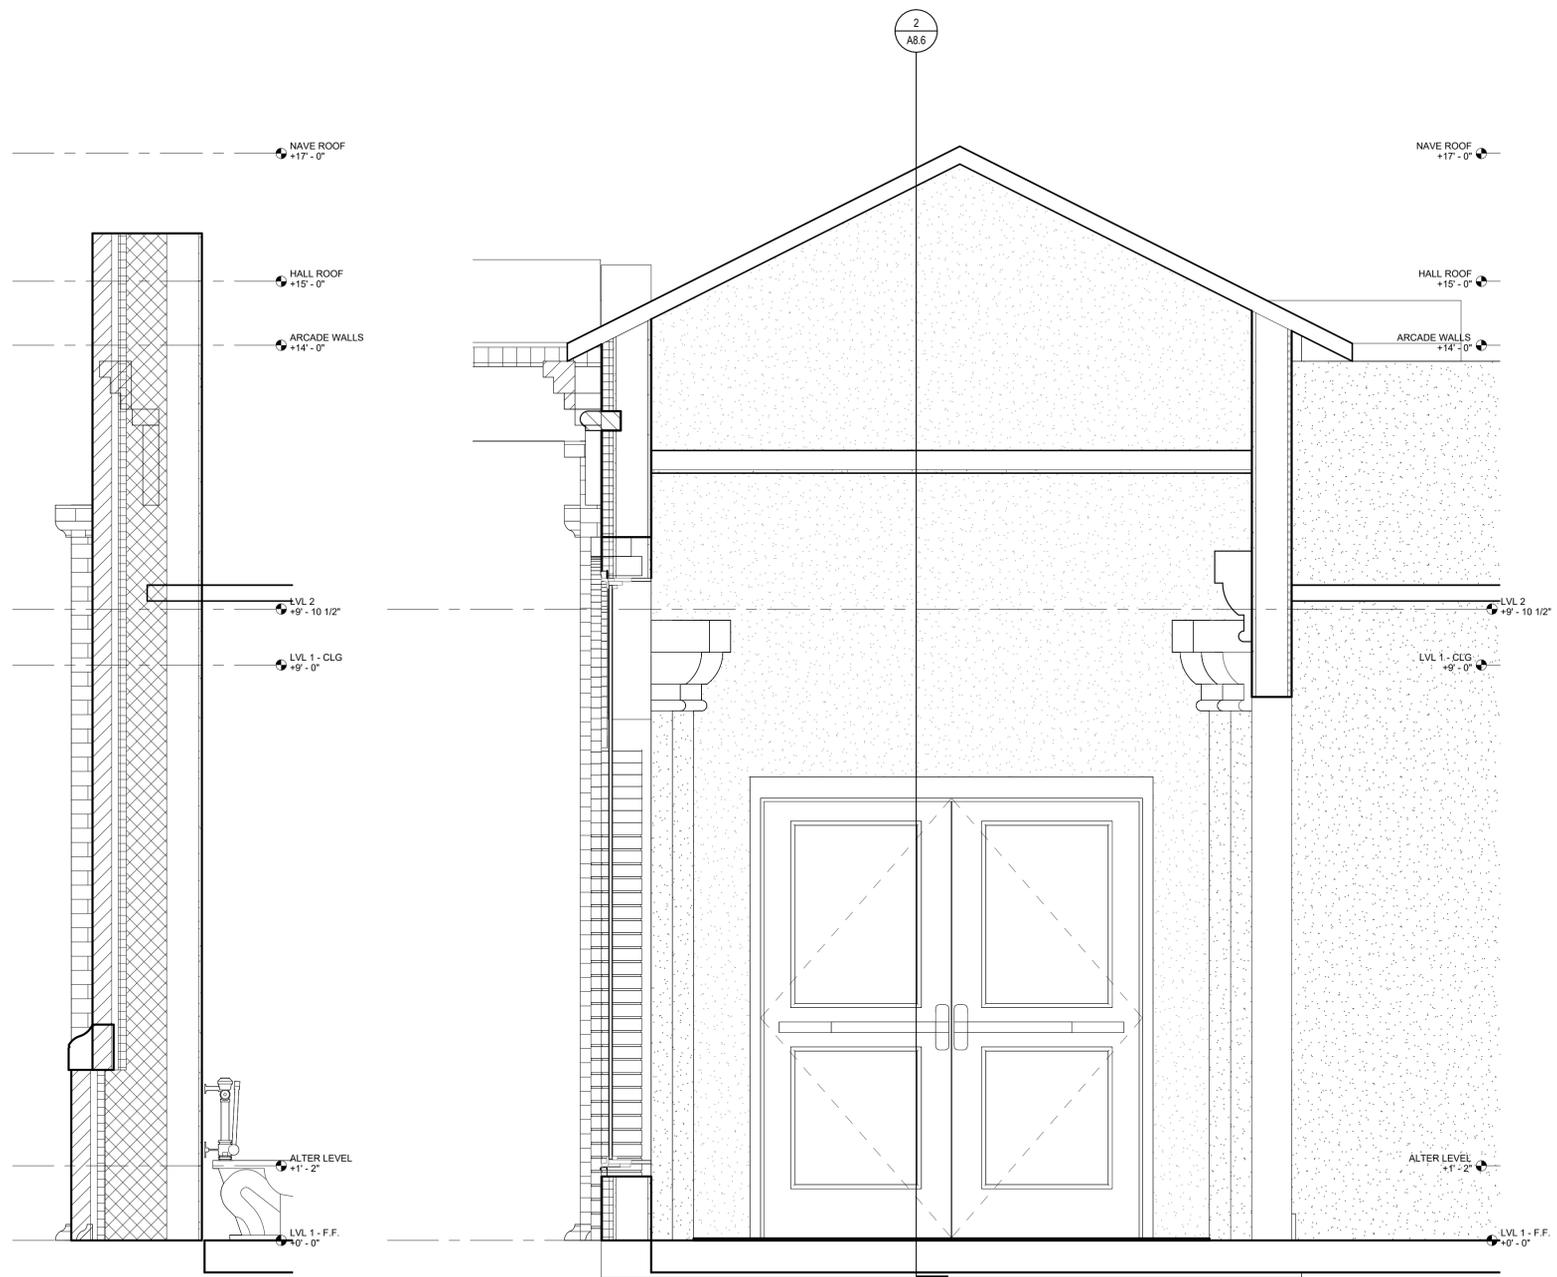

**1** Section 19  
SCALE: 3/4" = 1'-0"

**2** Section 7  
SCALE: 3/4" = 1'-0"

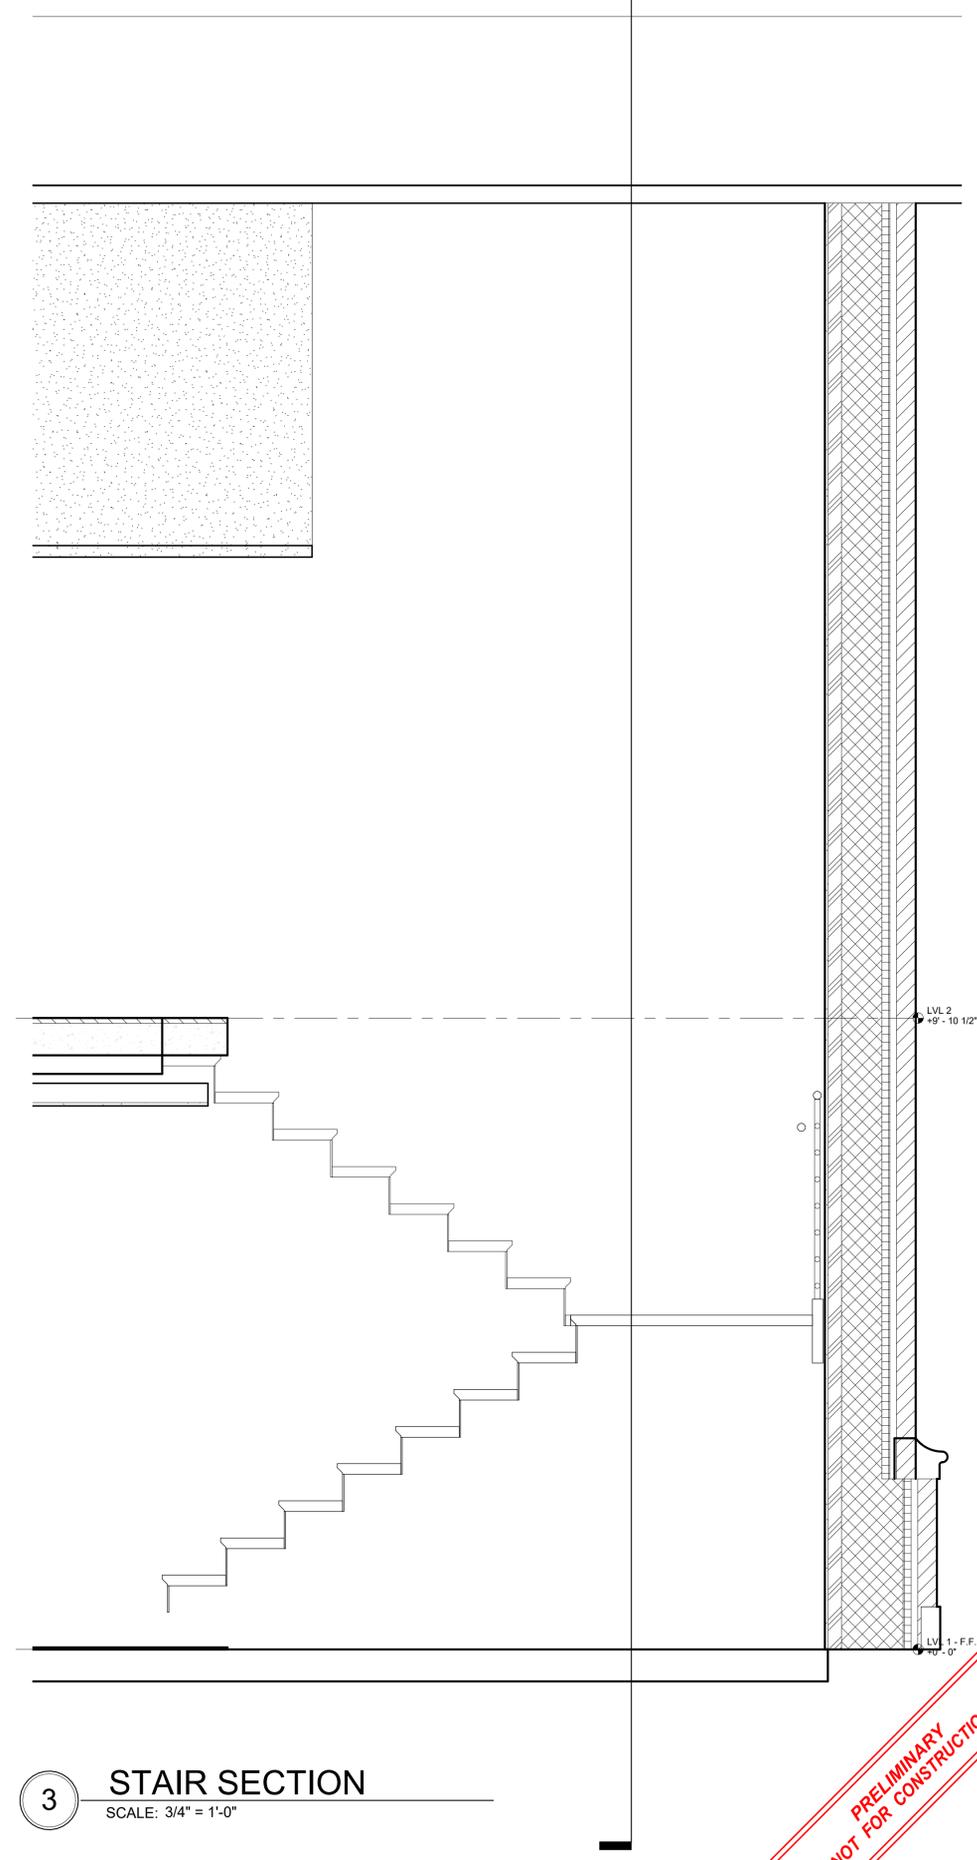

**3** STAIR SECTION  
SCALE: 3/4" = 1'-0"

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**ST. NICHOLAS ORTHODOX CHURCH**  
9100 Youree Dr, Shreveport, LA 71115

Date: 10/31/2025  
REVISION DATE


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Project #: 2505  
Sheet:

**A8.4**

WALL SECTIONS


**PRELIMINARY NOT FOR CONSTRUCTION**

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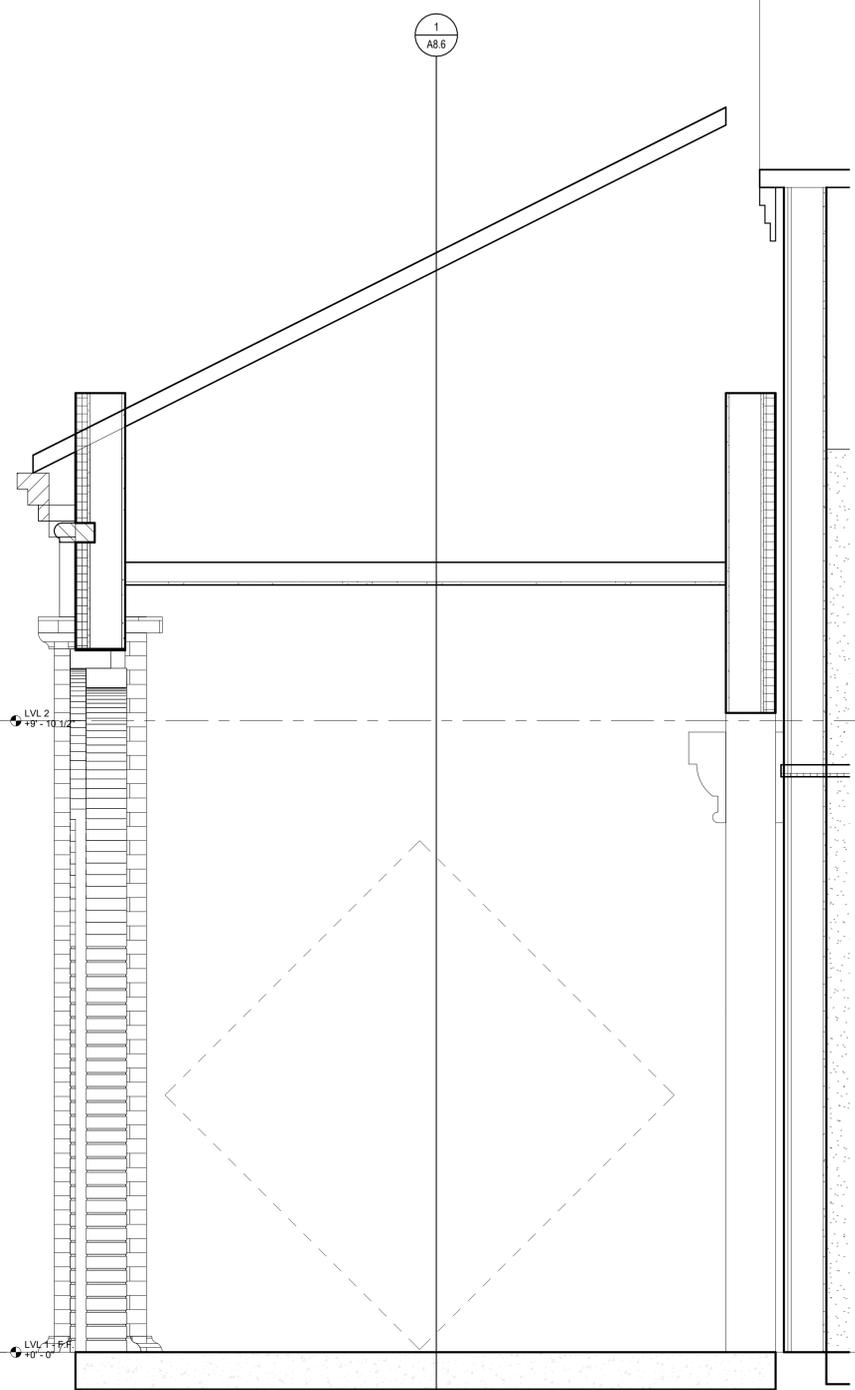


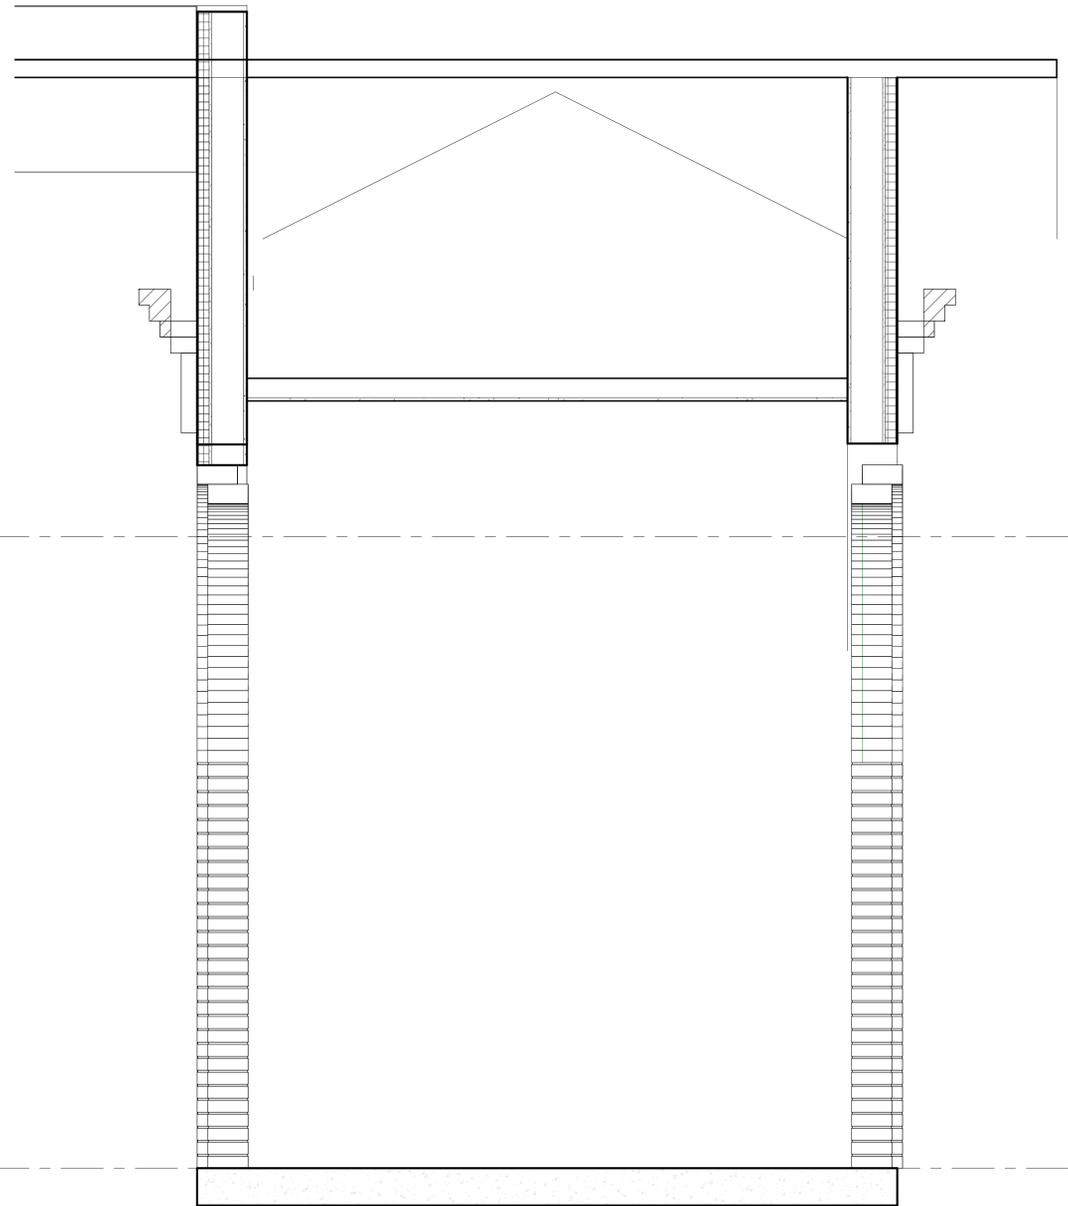- NAVE ROOF  
+17'-0"
- HALL ROOF  
+15'-0"
- ARCADE WALLS  
+14'-0"
- LVL 2  
+9'-10 1/2"
- LVL 1 - CLG  
+9'-0"
- ALTER LEVEL  
+1'-2"
- LVL 1 - F.F.  
+0'-0"

1 ARCADE SECTION @ WALK-THRU  
SCALE: 3/4" = 1'-0"

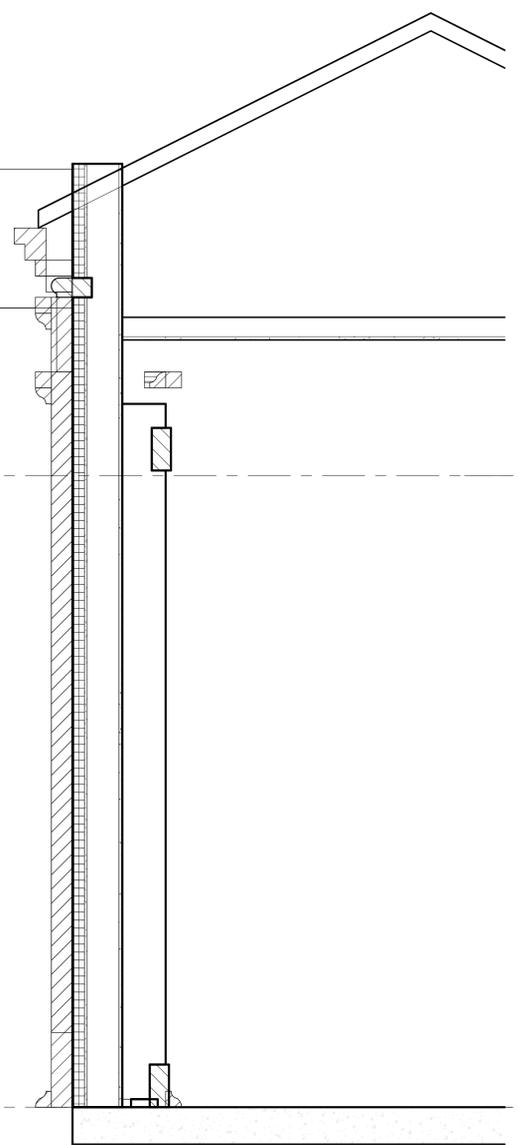

2 ARCADE SECTION @ COLUMN  
SCALE: 3/4" = 1'-0"



3 ARCADE TIE-IN SECTION  
SCALE: 3/4" = 1'-0"

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Date: 10/31/2025  
REVISION DATE

Drawn by: LCM  
Checked by: Checker  
Project #: 2505  
Sheet:


**A8.5**

WALL SECTIONS


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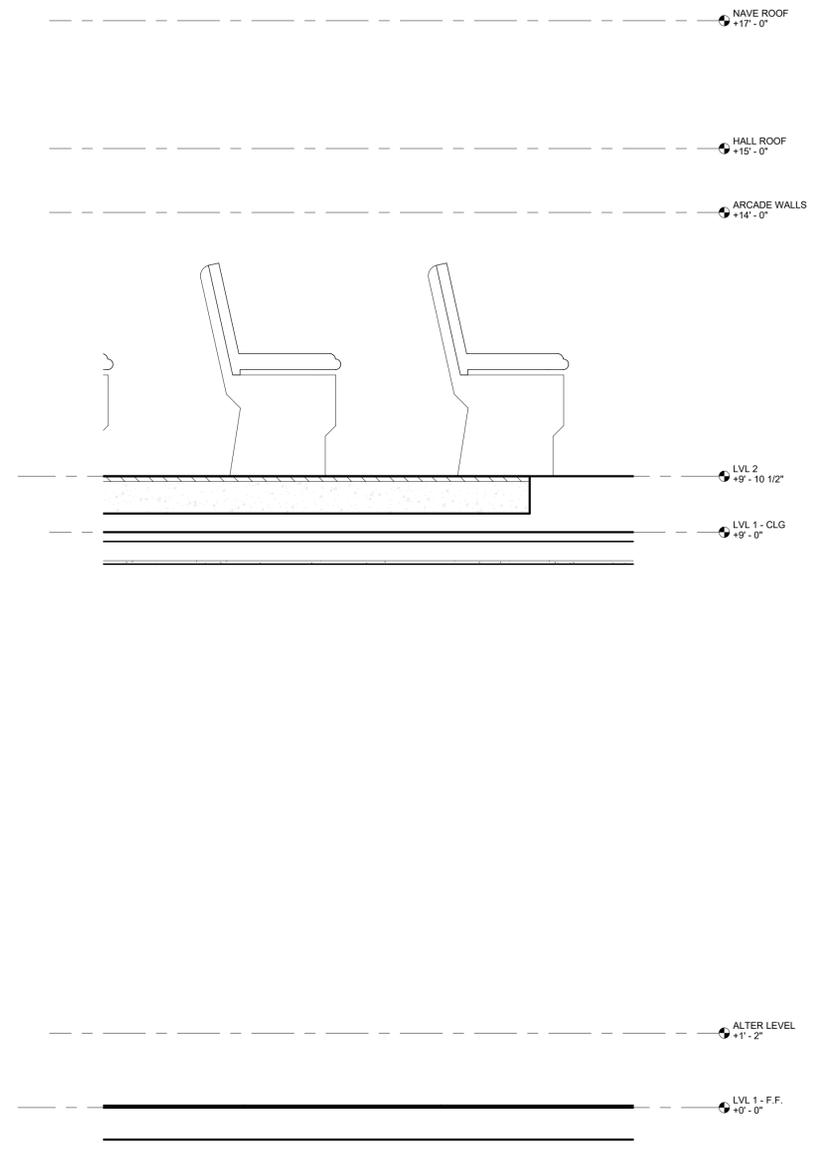
12/4/2025 11:44:31 AM



**1** ARCADE TIE-IN @ DOOR  
SCALE: 3/4" = 1'-0"

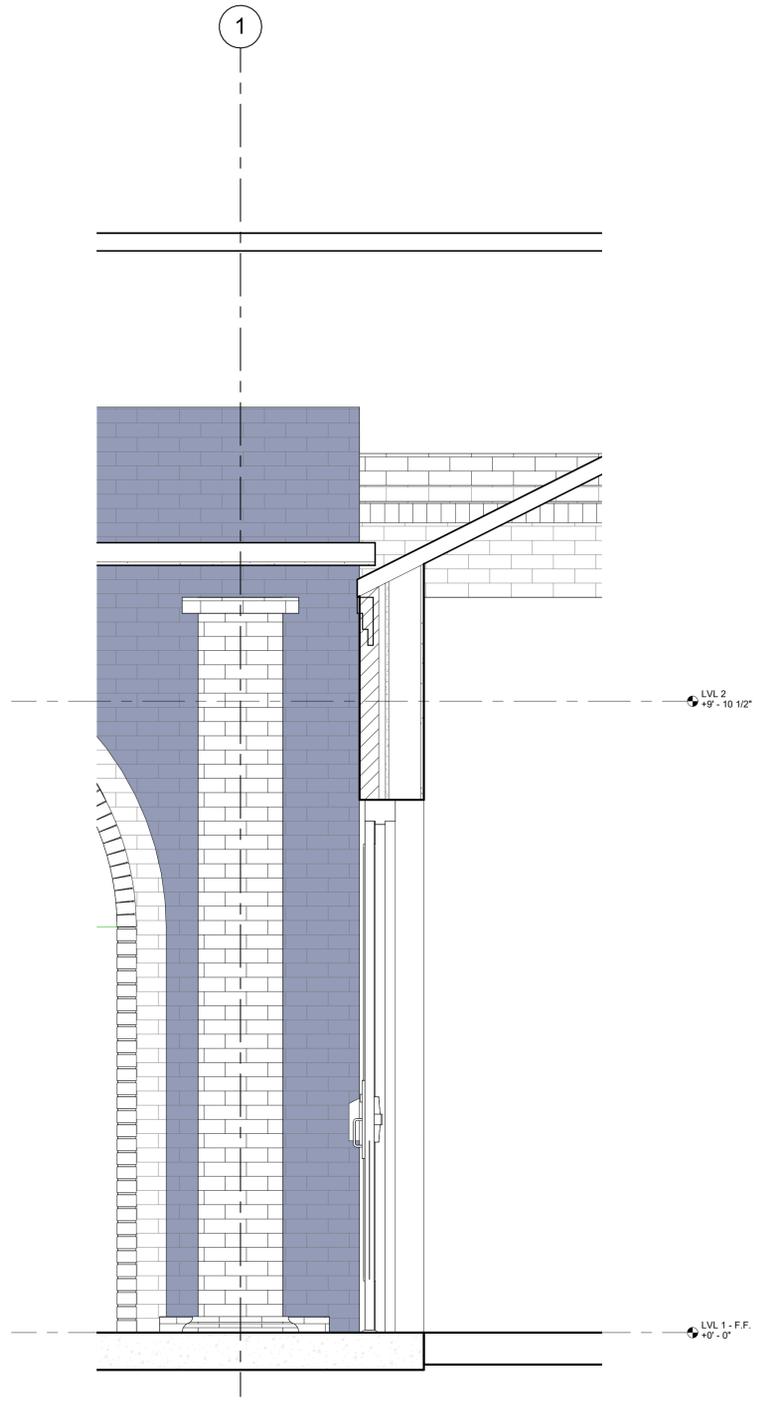

**2** Section 21  
SCALE: 3/4" = 1'-0"

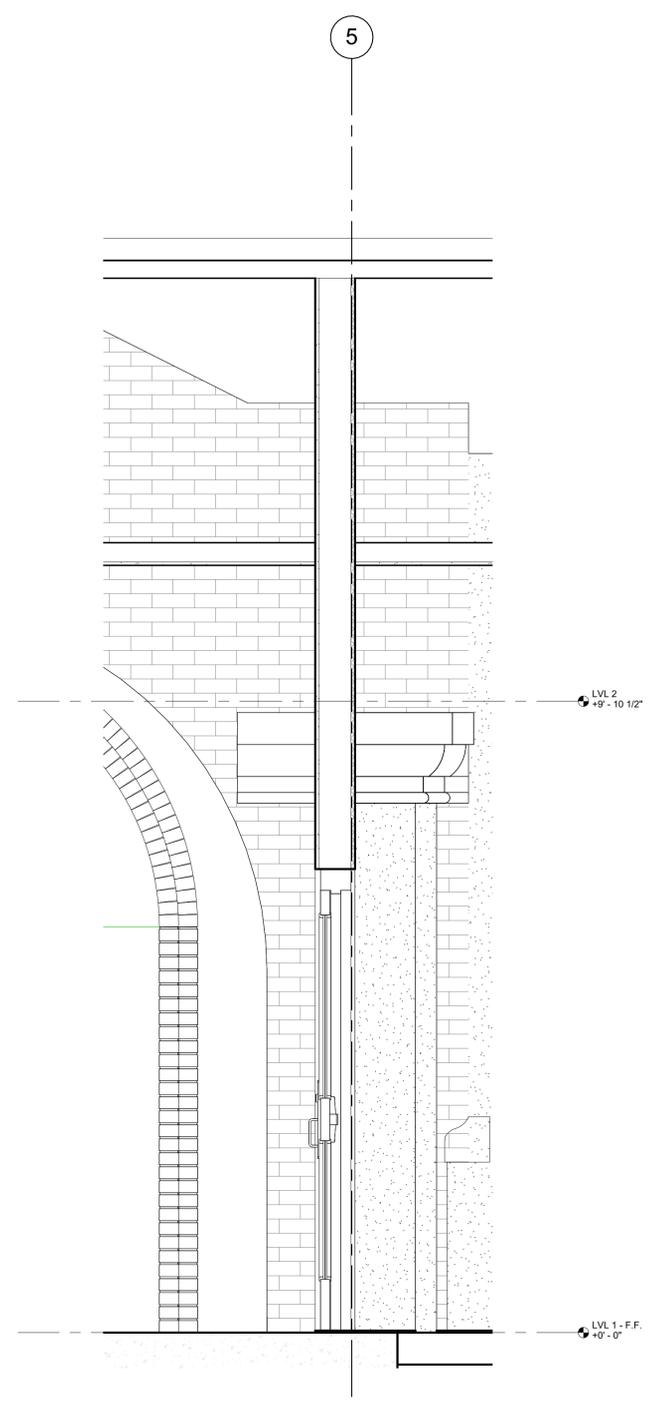

**3** MEZZANINE FRONT  
SCALE: 3/4" = 1'-0"

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Date:	10/31/2025
REVISION	DATE

Drawn by: LCM  
Checked by: Checker  
Project #: 2505  
Sheet:


**A8.6**

WALL SECTIONS


**PRELIMINARY NOT FOR CONSTRUCTION**

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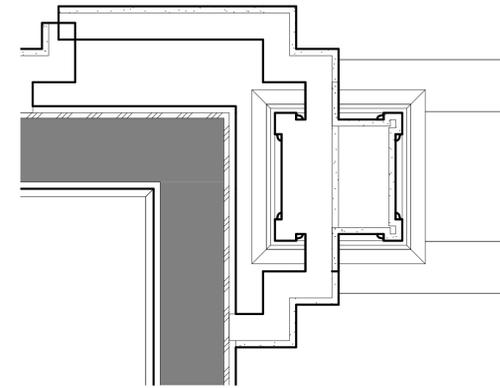
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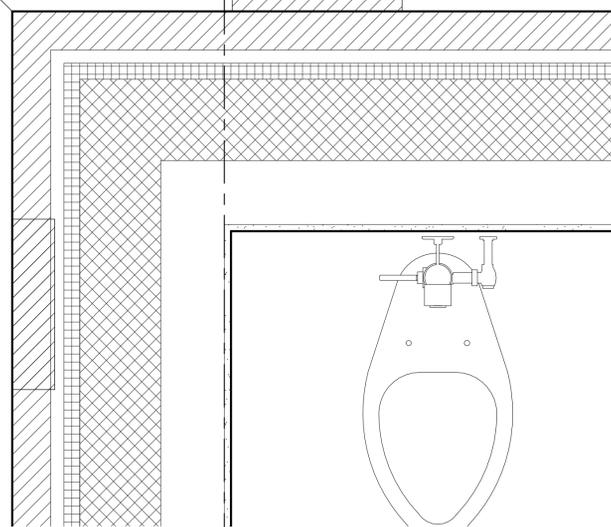
1 BRICK COLUMN @ ARCH CANOPY  
SCALE: 1 1/2" = 1'-0"

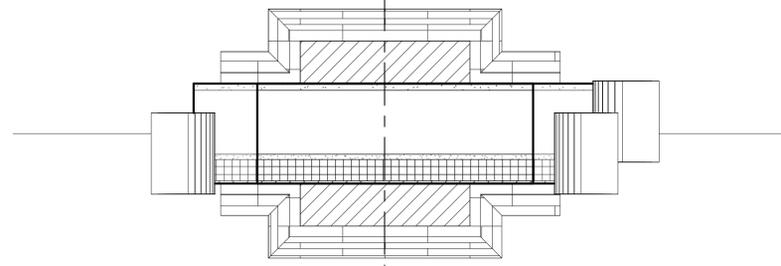


4 INT - OUTSIDE CORNER DETAIL  
SCALE: 1 1/2" = 1'-0"

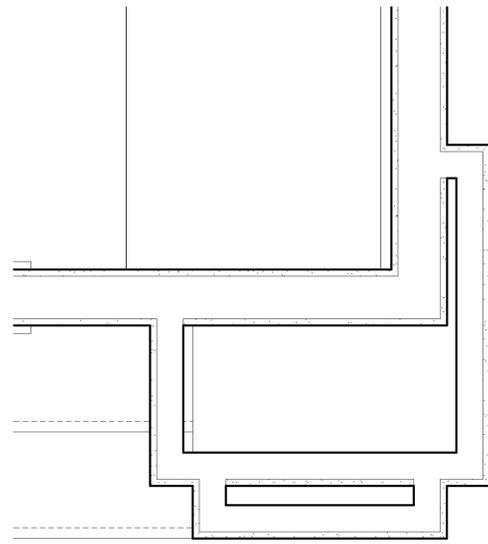

7 INT. - PILASTER  
SCALE: 1 1/2" = 1'-0"




2 PILASTER - OUTSIDE CORNER  
SCALE: 1 1/2" = 1'-0"

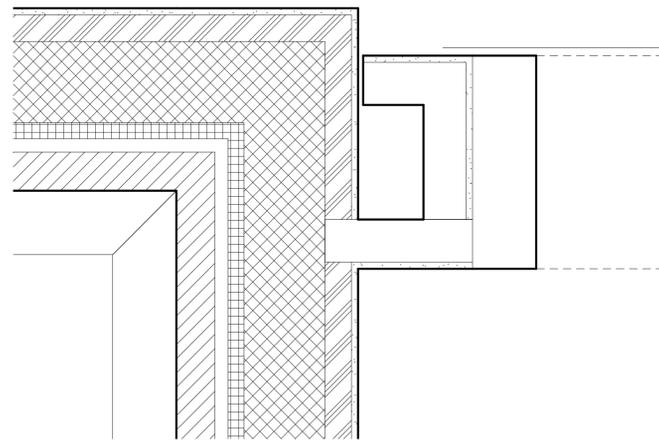

5 INT - OUTSIDE CORNER DETAIL1  
SCALE: 1 1/2" = 1'-0"

8 OUTSIDE CORNER DETAIL  
SCALE: 1 1/2" = 1'-0"

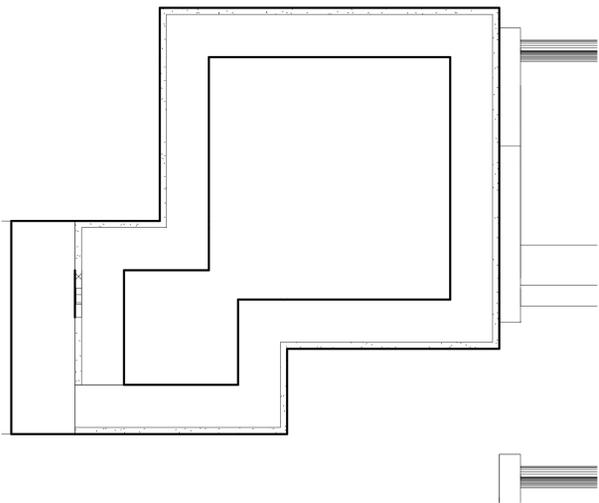

3 INT - COLUMN PLAN DETAIL  
SCALE: 1 1/2" = 1'-0"



6 INT - PILASTER PLAN DETAIL  
SCALE: 1 1/2" = 1'-0"

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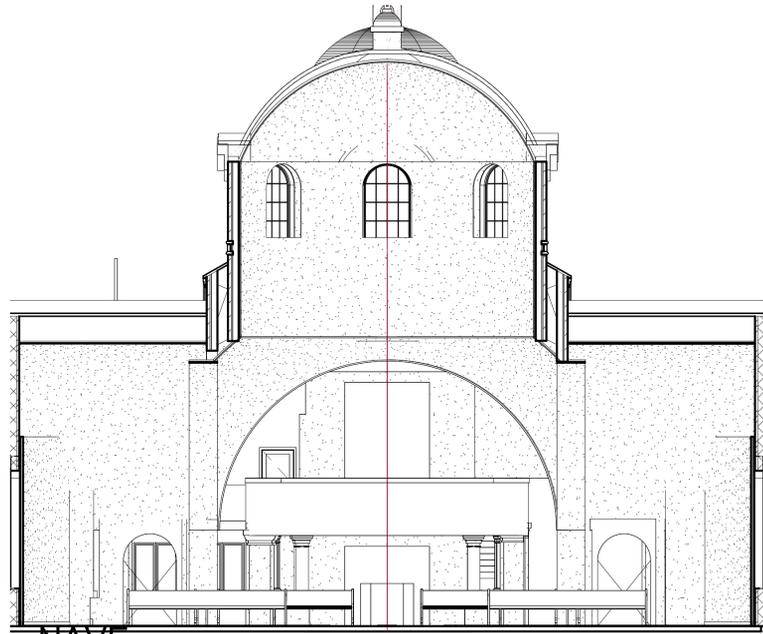
Drawn by: LCM / EBW  
Checked by: Checker  
Project #: 2505  
Sheet:

**A9.1**


ENLARGED DETAILS

**PRELIMINARY NOT FOR CONSTRUCTION**


0 1 2 3 4 5




1 NAVE  
SCALE: 1/8" = 1'-0"

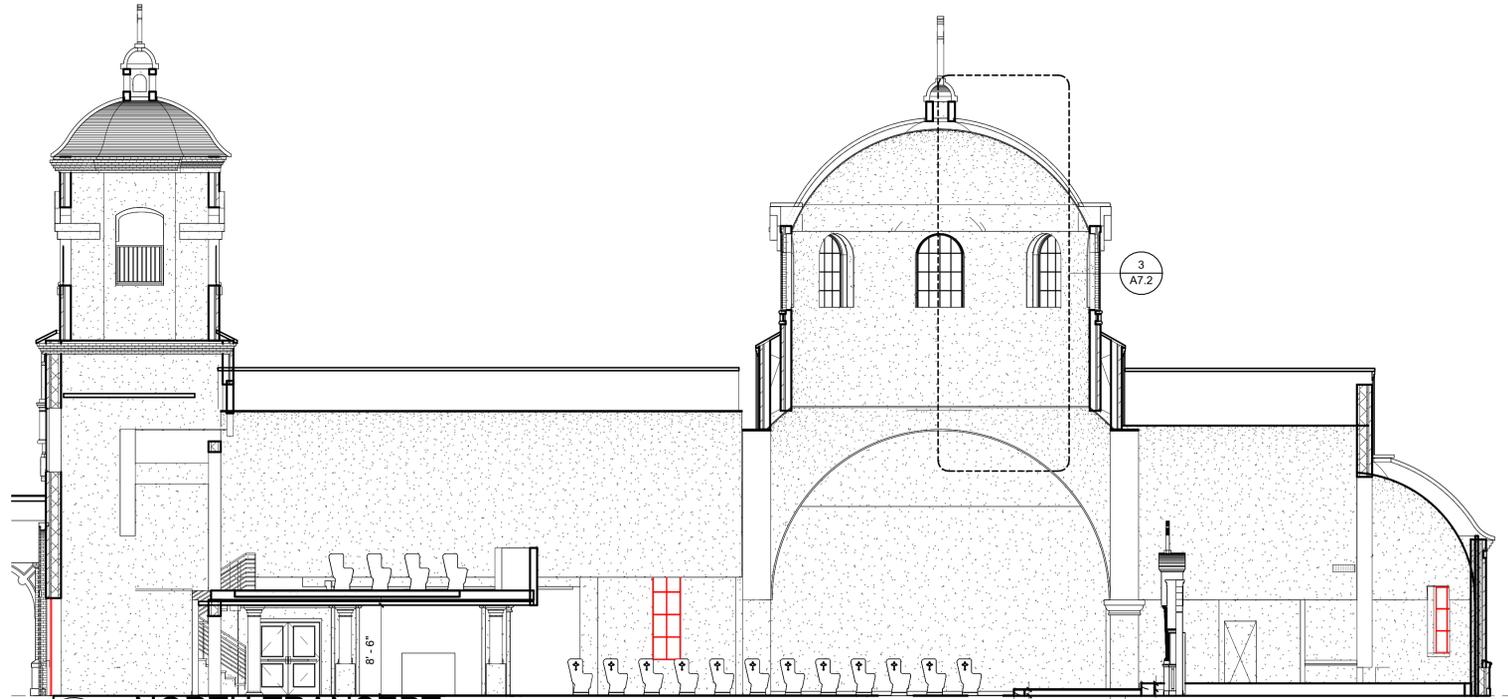

2 NORTH TRANSEPT  
SCALE: 1/8" = 1'-0"

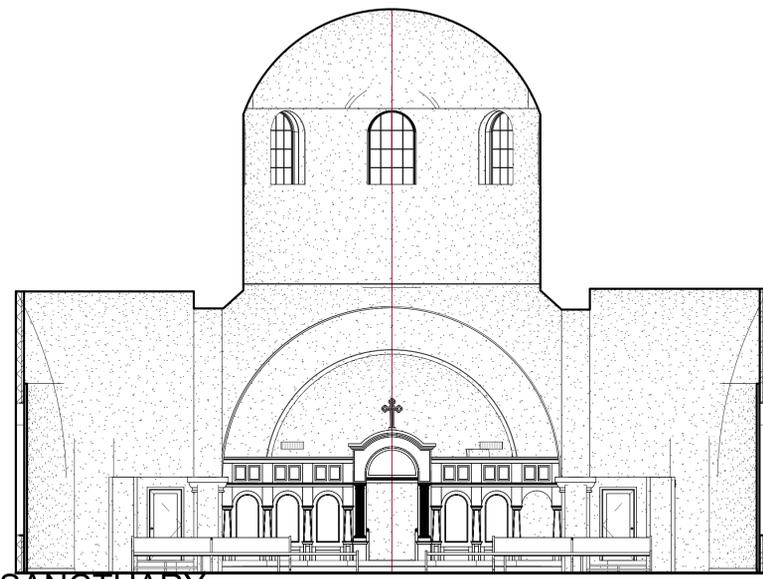

3 SANCTUARY  
SCALE: 1/8" = 1'-0"

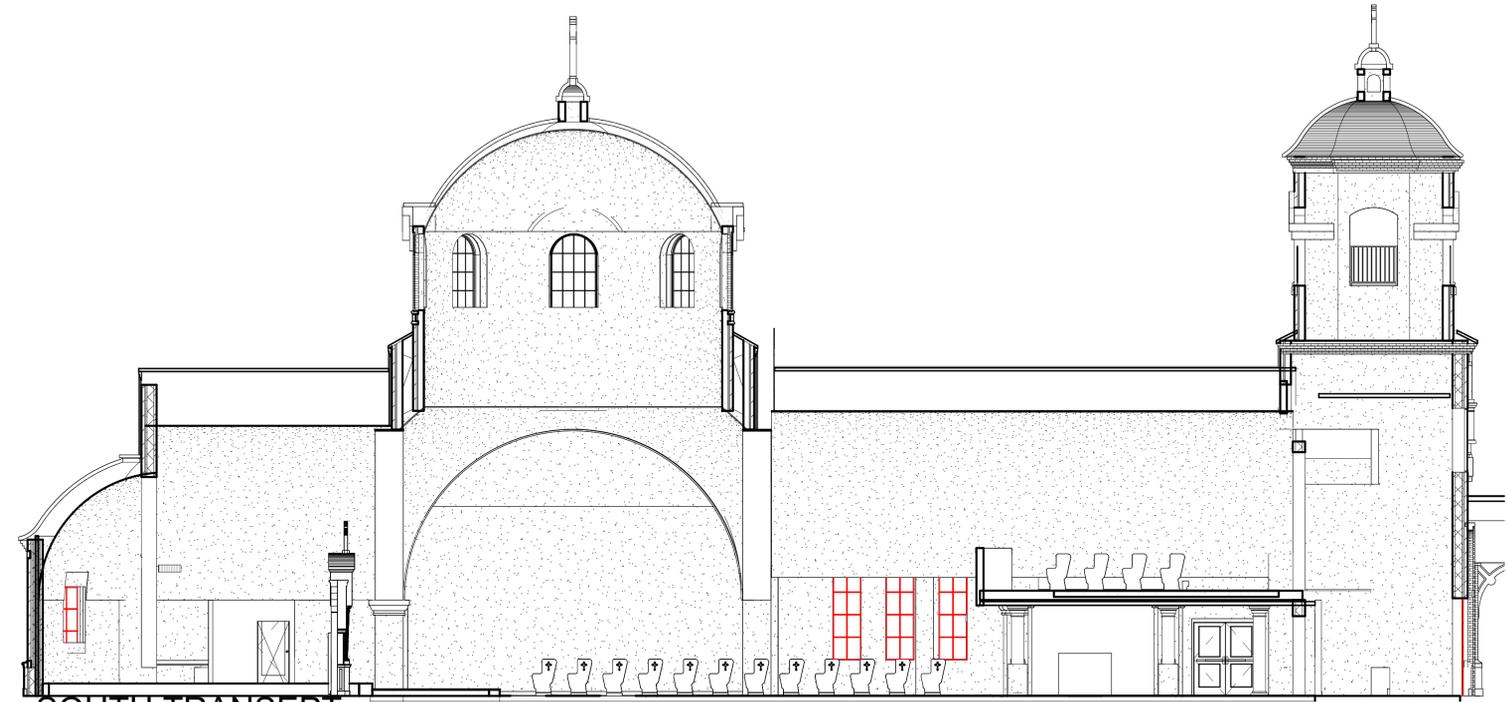

4 SOUTH TRANSEPT  
SCALE: 1/8" = 1'-0"

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Date: 10/31/2025  
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Drawn by: EBW  
Checked by: Checker  
Project #: 2505  
Sheet:

**A10.1**

INTERIOR ELEVATIONS

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0 1 2 3 4 5

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12/4/2025 11:44:38 AM

0 1 2 3 4 5

0 1 2 3 4 5

A

B

C

D

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**ST. NICHOLAS ORTHODOX CHURCH**  
9100 Youree Dr, Shreveport, LA 71115


Date:	10/31/2025
REVISION	DATE

Drawn by: EBW  
 Checked by: Checker  
 Project #: 2505  
 Sheet:


**A11.1**

MILLWORK DETAILS


**PRELIMINARY NOT FOR CONSTRUCTION**

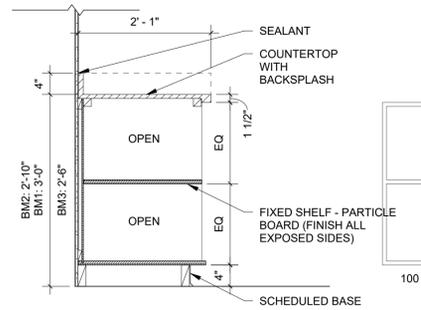


1 CASEWORK SECTION  
SCALE: 3/4" = 1'-0"

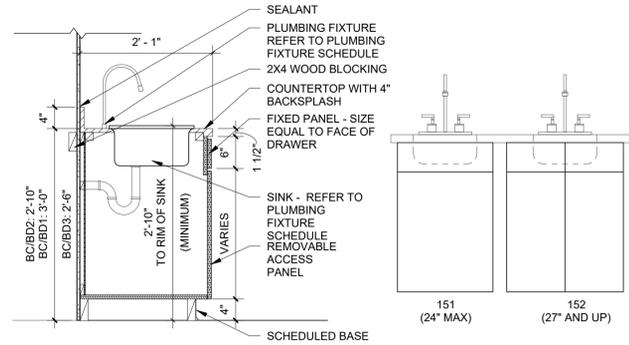


5 CASEWORK SECTION  
SCALE: 3/4" = 1'-0"

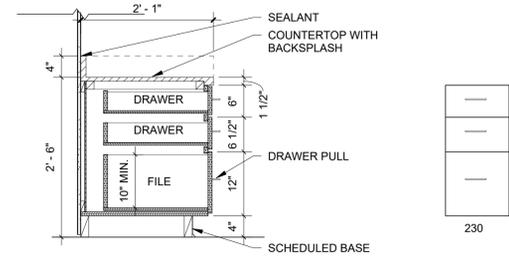


9 BASE CABINET - 2 DRAWER 1 FILE  
SCALE: 3/4" = 1'-0"

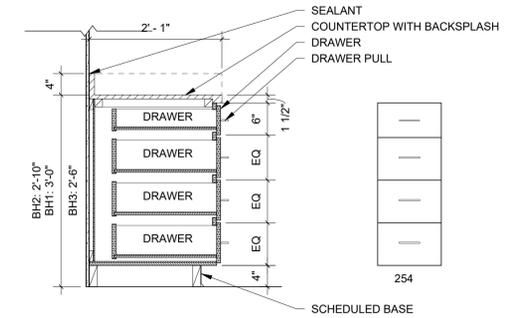


13 BASE CABINET - 4 DRAWER  
SCALE: 3/4" = 1'-0"

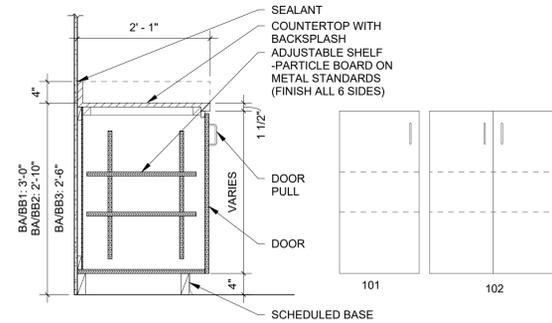


2 BASE CABINET - 2 DOOR  
SCALE: 3/4" = 1'-0"

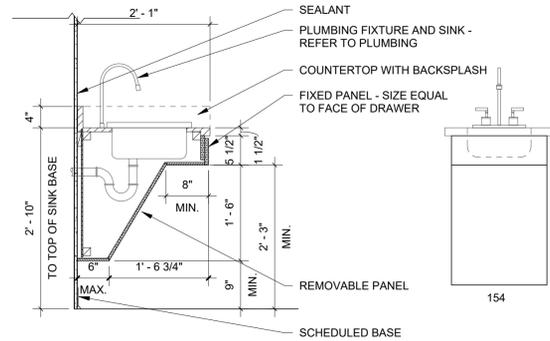


6 BASE CABINET - ADA SINK SKIRT  
SCALE: 3/4" = 1'-0"

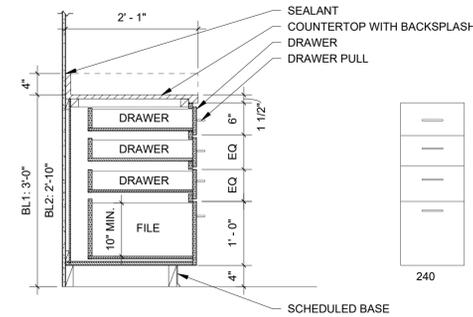


10 BASE CABINET - 3 DRAWER 1 FILE  
SCALE: 3/4" = 1'-0"

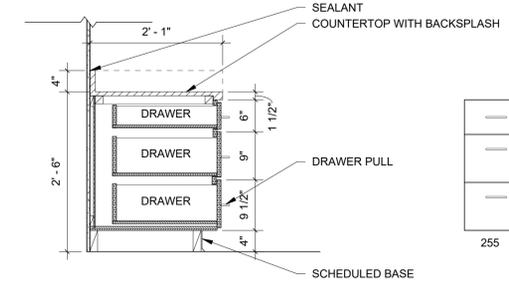


14 BASE CABINET - 3 DRAWER  
SCALE: 3/4" = 1'-0"

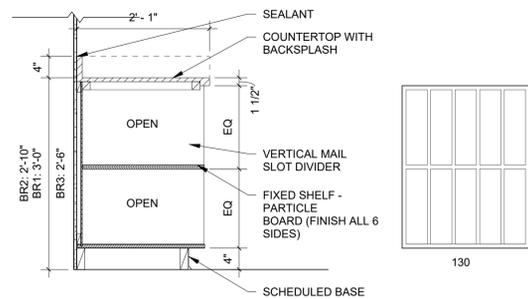


3 BASE CABINET - VERTICALE MAIL  
SCALE: 3/4" = 1'-0"

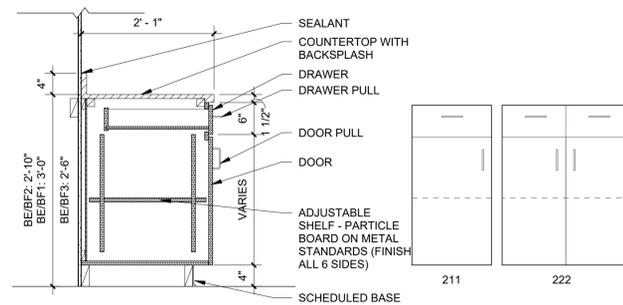


7 BASE CABINET - 1 DWR 1 DOOR  
SCALE: 3/4" = 1'-0"

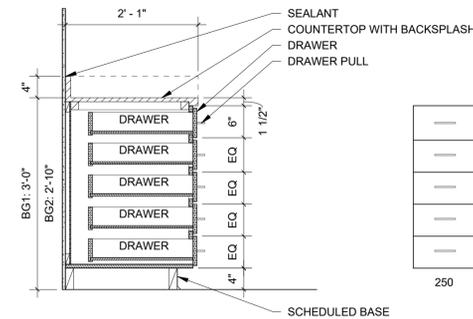


11 BASE CABINET - 5 DRAWER  
SCALE: 3/4" = 1'-0"

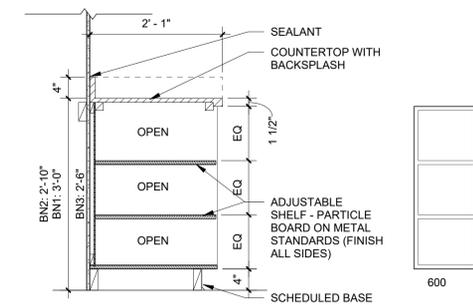


15 CASEWORK SECTION  
SCALE: 3/4" = 1'-0"

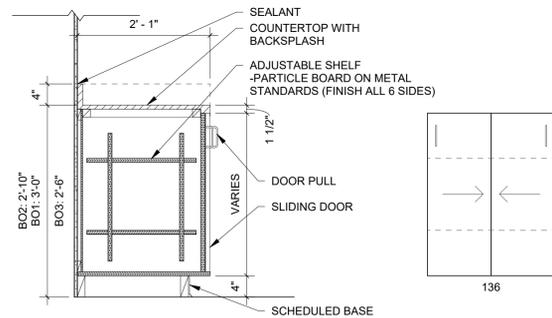


4 BASE CABINET - SLIDING DOOR  
SCALE: 3/4" = 1'-0"

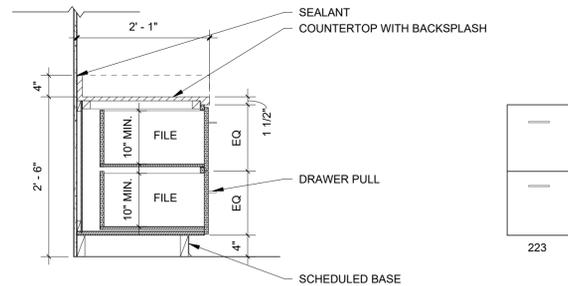

8 BASE CABINET - 2 FILE  
SCALE: 3/4" = 1'-0"

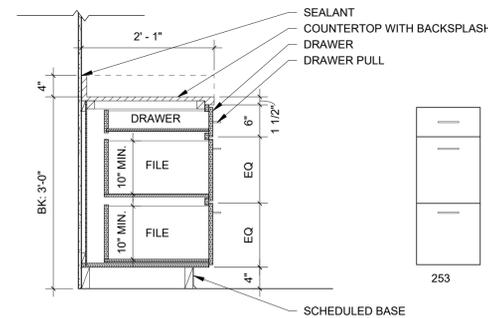

12 BASE CABINET - 1 DRAWER 2 FILE  
SCALE: 3/4" = 1'-0"

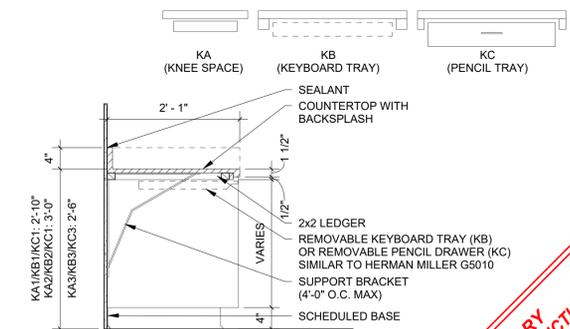

16 KA/KB/KC - KNEE SPAC  
SCALE: 3/4" = 1'-0"

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12/4/2025 11:44:41 AM

**DOOR SCHEDULE**

Mark	Door Size			Frame							Hardware		Comments			
	Width	Height	Thickness	Type Mark	Door Material	Finish	Under Cut	Material	Type	Finish	Head	Jamb		Sill	Fire Rating Label	Set No.
101	8'-0"	8'-0"	0'-1 3/4"	UUU	ALUM.											
102	3'-0"	8'-0"	0'-1 3/4"	25											107	
104	6'-0"	8'-0"	0'-1 3/4"	VVV	ALUM.										105	
105	3'-0"	8'-0"	0'-1 3/4"	25												
108	3'-0"	7'-0"	0'-1 3/8"	SSSS											126	
110	6'-0"	6'-11"	0'-1 3/4"	WWW	ALUM.										116	
111	6'-0"	6'-11"	0'-1 3/4"	WWW	ALUM.										115	
112	3'-0"	6'-8"	0'-1 3/8"	XXX												
113	3'-0"	6'-8"	0'-1 3/8"	XXX												
114	2'-8"	7'-0"	0'-1 3/4"	73											117	
115	2'-8"	7'-0"	0'-1 3/4"	73											118	
118	3'-0"	6'-8"	0'-1 3/8"	XXX											128	
119	3'-0"	6'-8"	0'-1 3/8"	XXX											121	
122	3'-0"	6'-8"	0'-1 3/4"	10											123	
123	6'-0"	6'-8"	0'-1 3/4"	17											105	
124	3'-0"	6'-8"	0'-1 3/4"	10											122	
125	3'-0"	6'-8"	0'-1 3/4"	10											105	
126	3'-0"	6'-8"	0'-1 3/4"	10											105	
127	3'-0"	7'-0"	0'-1 3/4"	11											105	
128	3'-0"	6'-8"	0'-1 3/4"	10											123	
129	3'-0"	7'-0"	0'-1 3/4"	11											105	
130	3'-0"	6'-8"	0'-1 3/4"	10											123	
131	3'-0"	6'-8"	0'-1 3/4"	10											123	
132	3'-0"	6'-8"	0'-1 3/4"	10											123	
133	3'-0"	6'-8"	0'-1 3/4"	10											105	
134	3'-0"	6'-8"	0'-1 3/4"	10											123	
135	6'-0"	6'-8"	0'-1 3/4"	17											123	
139	3'-0"	6'-8"	0'-1 3/8"	XXX											120	
141	2'-6"	6'-8"	0'-1 3/8"	YYY											126	
145	0'-0"	0'-0"		ZZZ											124	
146	0'-0"	0'-0"		ZZZ											126	
147	0'-0"	0'-0"		RRRR											116	
148	0'-0"	0'-0"		RRRR											116	
150	2'-6"	6'-8"	0'-1 3/8"	YYY											126	
154	0'-0"	0'-0"		NNNN											116	
155	0'-0"	0'-0"		NNNN											116	
156	0'-0"	0'-0"		NNNN											116	
161	3'-0"	6'-8"	0'-1 3/8"	XXX											201	
162	8'-0"	8'-0"	0'-1 3/4"	UUU	ALUM.										114	
172	3'-0"	8'-0"		UUUU												
174	3'-0"	6'-8"	0'-1 3/8"	XXX												
175	2'-6"	6'-8"	0'-1 3/8"	YYY												
176	6'-0"	6'-11"	0'-1 3/4"	WWW	ALUM.										128	
183	3'-0"	7'-0"	0'-1 3/4"	28											205	
184	3'-0"	6'-8"	0'-1 3/8"	XXX											126	
186	0'-0"	0'-0"		NNNN											116	
187	0'-0"	0'-0"		NNNN											116	
188	3'-0"	8'-0"		UUUU												
189	0'-0"	0'-0"		NNNN												
190	0'-0"	0'-0"		VVVV											120	
191	7'-8"	9'-2"		TTTT											133	
192	0'-0"	0'-0"		VVVV											136	
192	0'-0"	0'-0"		RRRR											205	

**OPENING SCHEDULE LEGEND:**

<b>DOOR:</b>	ALUMINUM
GL	GLAZING, REFER TO GLAZING LEGEND
HW	HOLLOW CORE WOOD
HM	HOLLOW METAL PAINT
SCW	SOLID CORE WOOD, RATED OR NON-RATED
<b>FRAME:</b>	ALUMINUM
AL	HOLLOW METAL
HM	WOOD
WD	
<b>GLAZING:</b>	
A	ART GLASS
B	BULLET PROOF GLASS
C	CLEAR GLASS
F	FIRE RATED
L	LEADED GLASS
P	PLASTIC
R	ARCHITECTURAL RESIN
S	SPANDREL
T	TEMPERED GLASS
TEX	TEXTURED GLASS
W	WIRE GLASS (BAROQUE PATTERN)
<b>HINGES:</b>	
H1	BALL BEARING BUTT HINGES
H2	CONTINUOUS HINGES
H3	ELECTRIFIED CONTINUOUS HINGES
H4	CONTINUOUS GEARED HINGES
H5	CONCEALED HINGE
H6	PIVOTS
H7	SWING CLEAR OFFSET HINGE
H8	DOUBLE ACTING SPRING PIVOT
<b>LATCH:</b>	
L1	PASSAGE
L2	EXIT DEVICE (SINGLE DOOR)
L3	PRIVACY
L4	HOSPITAL PUSH/PULL
L5	INACTIVE TRIM
L6	OFFICE/ENTRANCE
L7	PUSH/PULL
L8	CLASSROOM
L9	STOREROOM
L10	HOTEL/MOTEL
L11	MANUAL TOP FLUSH BOLTS
L12	AUTOMATIC FLUSH BOLTS
L13	BOTTOM FLUSH BOLT
L14	DEADBOLT
L15	CYLINDER ONLY
L16	ELECTRONIC EXIT DEVICE
L17	STOREROOM LOCKSET WITH INTEGRAL KEYPAD
L18	ANTI-LIGATURE
L19	CONCEALED VERTICAL ROD PANIC DEVICE (DOUBLE DOOR)
L20	SURFACE MOUNTED VERTICAL ROD PANIC DEVICE (DOUBLE DOOR)
L21	PUSH PADS/PULL HANDLES
<b>CONTROL:</b>	
C1	CLOSER, STANDARD
C2	MAGNETIC HOLD OPENS
C3	CLOSER W/ DELAYED ACTION
C4	WALL STOP
C5	FLOOR STOP
C6	OVERHEAD STOP
C7	MAGNETIC LOCK
C8	ELECTRIC STRIKE
C9	AUTOMATIC DOOR OPERATOR
C10	DOOR OPERATOR PUSH PADS
C11	ACCESS CONTROL (CARD READER/KEYPAD)
C12	COORDINATOR
C13	COMBO STRIKE AND RESCUE STOP
C14	CLOSER, CONCEALED
C15	CLOSER W/ INTEGRAL STOP
C16	ROLLER BUMPER
C17	DELAYED EGRESS SYSTEM
C18	CLOSER WITH HOLD OPEN
<b>PROTECTION:</b>	
P1	KICK PLATE (8" HIGH)
P2	DOOR ARMOR (34" HIGH)
P3	MOP PLATE (4" HIGH)
P4	DOOR EDGE PROTECTION
<b>SEAL:</b>	
S1	WEATHER STRIPPING
S2	THRESHOLD
S3	ASTRAGAL
S4	AUTOMATIC DOOR BOTTOM
S5	PERIMETER GASKETING
S6	DRIP STRIP
S7	SWEEP
<b>MISC ABBREVIATIONS:</b>	
ETR	EXISTING TO REMAIN
N/A	NOT APPLICABLE
<b>REMARKS:</b>	
1.	LEAD LINED DOOR AND FRAME - REFER TO PHYSICIST REPORT
2.	INSULATED AND GALVANIZED DOOR AND FRAME
3.	ADD COAT HOOK TO MATCH DOOR HARDWARE FINISH.
4.	HARDWARE BY DOOR MANUFACTURER
5.	ADD SMOKE & DRAFT CONTROL KIT W/ POSITIVE LATCHING
6.	NON-REMOVABLE PIN
7.	GALVANIZED FRAME
8.	PROVIDE ONE LATCH FOR BOTTOM LEAF. TOP LEAF LATCHED TO BOTTOM
9.	LEAF WITH SURFACE BOLT
10.	PROVIDE DOOR PROTECTION ON BOTH SIDES
11.	KEYED BOTH SIDES
	RETRACTABLE PINS

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 ARCHITECTURE + INTERIOR DESIGN  
 333 TEXAS STREET, SUITE 1900 SHREVEPORT, LA 71101

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**NOT FOR CONSTRUCTION**

NEW TEMPLE BUILDING FOR  
**ST. NICHOLAS ORTHODOX CHURCH**  
 9100 Youree Dr, Shreveport, LA 71115

Date: 10/31/2025  
 REVISION DATE

Drawn by: EBW  
 Checked by: Checker  
 Project #: 2505  
 Sheet:

**A12.1**

DOOR SCHEDULE

**PRELIMINARY NOT FOR CONSTRUCTION**

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## WINDOW SCHEDULE

Type Mark	R.O.		Type	Manufacturer	Model	Material	Finish	Head	Jamb	Sill	Glazing		Head Height	Comments
	Width	Height									Thickness	Type		
MMM	2' - 11 1/2"	2' - 11 1/2"	Window-Casement-Marvin-Picture-Essential	Marvin Windows and Doors	ESCAP4040								8' - 3 3/4"	
MMM	2' - 11 1/2"	2' - 11 1/2"	Window-Casement-Marvin-Picture-Essential	Marvin Windows and Doors	ESCAP4040								8' - 3 3/4"	
MMM	2' - 11 1/2"	2' - 11 1/2"	Window-Casement-Marvin-Picture-Essential	Marvin Windows and Doors	ESCAP4040								8' - 3 3/4"	
MMM	2' - 11 1/2"	2' - 11 1/2"	Window-Casement-Marvin-Picture-Essential	Marvin Windows and Doors	ESCAP4040								8' - 3 3/4"	
EEE	6' - 0"	6' - 0"	Window-Fixed-Round2										27' - 0"	
CCCC	3' - 9 3/4"	5' - 2 3/8"	Window-Fixed-Marvin-Aluminum_Direct_Glaze_Round_Top_RT6_Elevate2	Marvin Windows and Doors	IRTM 7225 DR								20' - 2 3/8"	
UUU	4' - 4 3/4"	6' - 9 7/8"	Window-Fixed-Marvin-Aluminum_Direct_Glaze_Round_Top_RT6_Elevate	Marvin Windows and Doors	IRTM 7225 DR								10' - 9 7/8"	
CCCC	3' - 9 3/4"	5' - 2 3/8"	Window-Fixed-Marvin-Aluminum_Direct_Glaze_Round_Top_RT6_Elevate2	Marvin Windows and Doors	IRTM 7225 DR								20' - 2 3/8"	
CCCC	3' - 9 3/4"	5' - 2 3/8"	Window-Fixed-Marvin-Aluminum_Direct_Glaze_Round_Top_RT6_Elevate2	Marvin Windows and Doors	IRTM 7225 DR								25' - 8 3/8"	
HHHHH	4' - 4 3/4"	7' - 2 7/8"	dome window1	Marvin Windows and Doors	IRTM 7225 DR								7' - 2 7/8"	
HHHHH	4' - 4 3/4"	7' - 2 7/8"	dome window1	Marvin Windows and Doors	IRTM 7225 DR								7' - 2 7/8"	
HHHHH	4' - 4 3/4"	7' - 2 7/8"	dome window1	Marvin Windows and Doors	IRTM 7225 DR								7' - 2 7/8"	
HHHHH	4' - 4 3/4"	7' - 2 7/8"	dome window1	Marvin Windows and Doors	IRTM 7225 DR								7' - 2 7/8"	
HHHHH	4' - 4 3/4"	7' - 2 7/8"	dome window1	Marvin Windows and Doors	IRTM 7225 DR								7' - 2 7/8"	
HHHHH	4' - 4 3/4"	7' - 2 7/8"	dome window1	Marvin Windows and Doors	IRTM 7225 DR								7' - 2 7/8"	
HHHHH	4' - 4 3/4"	7' - 2 7/8"	dome window1	Marvin Windows and Doors	IRTM 7225 DR								7' - 2 7/8"	
V	7' - 3"	5' - 6"	SA - Window										8' - 6"	
V	7' - 3"	5' - 6"	SA - Window										8' - 6"	
W	5' - 7"	3' - 0"	SA - Window										6' - 0"	
W	5' - 7"	3' - 0"	SA - Window										6' - 0"	
WWWWW	2' - 1"	4' - 10"	SA - WindowRegular										7' - 10"	
UUU	4' - 4 3/4"	6' - 9 7/8"	Window-Fixed-Marvin-Aluminum_Direct_Glaze_Round_Top_RT6_Elevate	Marvin Windows and Doors	IRTM 7225 DR								10' - 9 7/8"	
PPPPP	5' - 4 3/4"	12' - 5 7/8"	Window-Fixed-Marvin-Aluminum_Direct_Glaze_Round_Top	Marvin Windows and Doors	IRTM 7225 DR								15' - 9 7/8"	
VVVV	3' - 2 3/4"	11' - 4 7/8"	Window-Fixed-Marvin-Aluminum_Direct_Glaze_Round_Top	Marvin Windows and Doors	IRTM 7225 DR								14' - 8 7/8"	
VVVV	3' - 2 3/4"	11' - 4 7/8"	Window-Fixed-Marvin-Aluminum_Direct_Glaze_Round_Top	Marvin Windows and Doors	IRTM 7225 DR								14' - 8 7/8"	
PPPP	5' - 4 3/4"	12' - 5 7/8"	Window-Fixed-Marvin-Aluminum_Direct_Glaze_Round_Top	Marvin Windows and Doors	IRTM 7225 DR								15' - 9 7/8"	
VVVV	3' - 2 3/4"	11' - 4 7/8"	Window-Fixed-Marvin-Aluminum_Direct_Glaze_Round_Top	Marvin Windows and Doors	IRTM 7225 DR								14' - 8 7/8"	
VVVV	3' - 2 3/4"	11' - 4 7/8"	Window-Fixed-Marvin-Aluminum_Direct_Glaze_Round_Top	Marvin Windows and Doors	IRTM 7225 DR								14' - 8 7/8"	
WWWWW	2' - 1"	4' - 10"	SA - WindowRegular										7' - 10"	
WWWWW	2' - 1"	4' - 10"	SA - WindowRegular										7' - 10"	
WWWWW	2' - 1"	4' - 10"	SA - WindowRegular										7' - 10"	
WWWWW	2' - 1"	4' - 10"	SA - WindowRegular										7' - 10"	
LLLLL	7' - 9 3/8"	9' - 2 1/2"	Window-Fixed-Marvin-Aluminum_Direct_Glaze_Round_Top	Marvin Windows and Doors	IRTM 7225 DR								10' - 2 1/2"	
LLLLL	7' - 9 3/8"	9' - 2 1/2"	Window-Fixed-Marvin-Aluminum_Direct_Glaze_Round_Top	Marvin Windows and Doors	IRTM 7225 DR								10' - 2 1/2"	
LLLLL	7' - 9 3/8"	9' - 2 1/2"	Window-Fixed-Marvin-Aluminum_Direct_Glaze_Round_Top	Marvin Windows and Doors	IRTM 7225 DR								10' - 2 1/2"	
OOOOO	3' - 0"	6' - 3"	HopesWindows.Inc.OldWorldSuite_Fixed	Hope's® Windows, Inc.									10' - 3"	
OOOOO	3' - 0"	6' - 3"	HopesWindows.Inc.OldWorldSuite_Fixed	Hope's® Windows, Inc.									10' - 3"	
NNNNN	2' - 3 1/2"	4' - 6"	HopesWindows.Inc.OldWorldSuite_Fixed	Hope's® Windows, Inc.									8' - 6"	
NNNNN	2' - 3 1/2"	4' - 6"	HopesWindows.Inc.OldWorldSuite_Fixed	Hope's® Windows, Inc.									8' - 6"	
MMMMM	2' - 8"	8' - 6"	HopesWindows.Inc.OldWorldSuite_Fixed	Hope's® Windows, Inc.									11' - 10 1/2"	
MMMMM	2' - 8"	8' - 6"	HopesWindows.Inc.OldWorldSuite_Fixed	Hope's® Windows, Inc.									11' - 10 1/2"	
MMMMM	2' - 8"	8' - 6"	HopesWindows.Inc.OldWorldSuite_Fixed	Hope's® Windows, Inc.									11' - 10 1/2"	
MMMMM	2' - 8"	8' - 6"	HopesWindows.Inc.OldWorldSuite_Fixed	Hope's® Windows, Inc.									11' - 10 1/2"	
NNNNN	2' - 3 1/2"	4' - 6"	HopesWindows.Inc.OldWorldSuite_Fixed	Hope's® Windows, Inc.									7' - 11 1/8"	
NNNNN	2' - 3 1/2"	4' - 6"	HopesWindows.Inc.OldWorldSuite_Fixed	Hope's® Windows, Inc.									7' - 11 1/8"	
KKKKK	3' - 0"	3' - 0"	HopesWindows.Inc.OldWorldSuite_Fixed	Hope's® Windows, Inc.									11' - 8 3/4"	
KKKKK	3' - 0"	3' - 0"	HopesWindows.Inc.OldWorldSuite_Fixed	Hope's® Windows, Inc.									11' - 9 3/4"	

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NEW TEMPLE BUILDING FOR  
**ST. NICHOLAS ORTHODOX CHURCH**  
9100 Youree Dr, Shreveport, LA 71115

Date: 10/31/2025  
REVISION DATE

Drawn by: EBW  
Checked by: Checker  
Project #: 2505  
Sheet:

A12.2

WINDOW SCHEDULE

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0 1 2 3 4 5

0 1 2 3 4 5

A

B

C

D

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**ST. NICHOLAS ORTHODOX CHURCH**  
9100 Youree Dr, Shreveport, LA 71115


Date:	10/31/2025
REVISION	DATE

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Checked by: Checker  
Project #: 2505  
Sheet:


**A12.3**

DOOR AND WINDOW DETAILS


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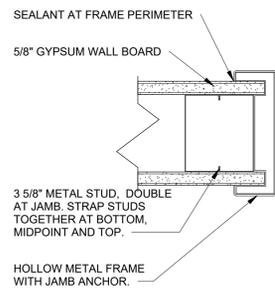
**1 HEAD DETAIL**  
SCALE: 3" = 1'-0"

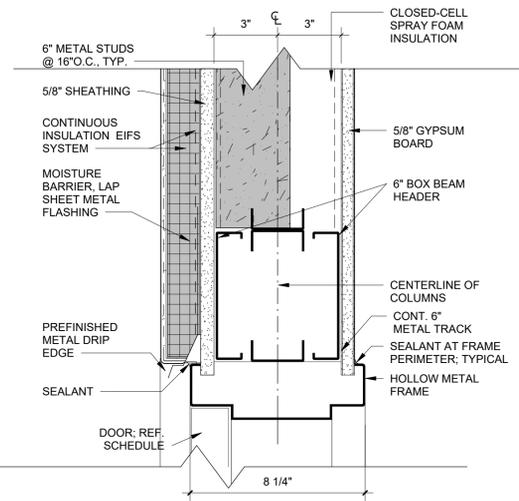


**4 HEAD DETAIL**  
SCALE: 3" = 1'-0"

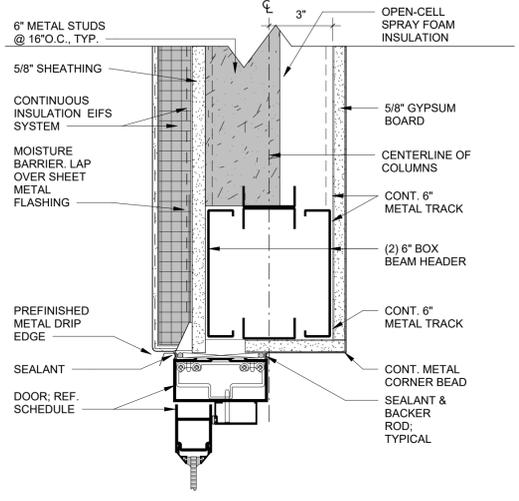


**7 HM CASED OPENING HEAD**  
SCALE: 3" = 1'-0"

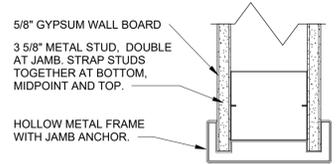


**8 HM CASED OPENING JAMB**  
SCALE: 3" = 1'-0"

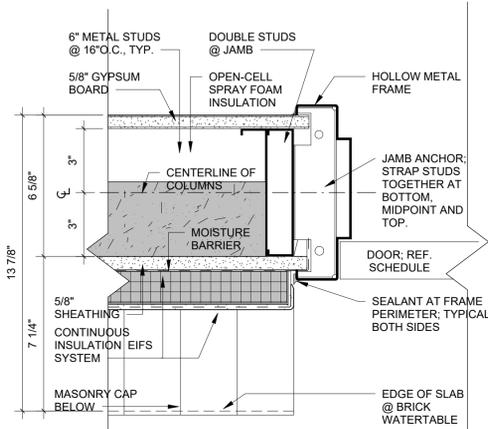


**2 EXT. JAMB DETAIL HM FRAME @ EIFS**  
SCALE: 3" = 1'-0"

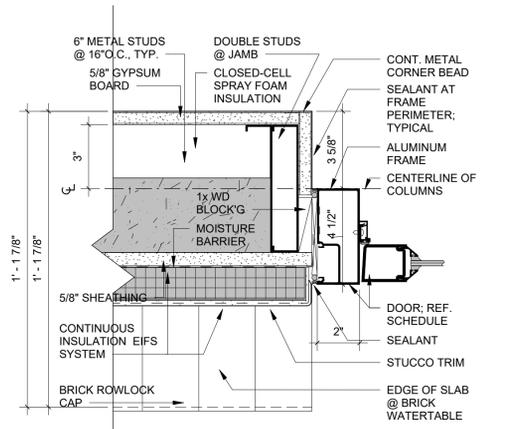

**5 JAMB DETAIL**  
SCALE: 3" = 1'-0"

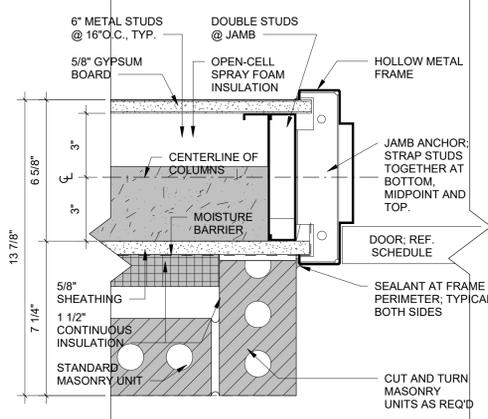

**3 EXT. JAMB DETAIL HM FRAME @ EIFS**  
SCALE: 3" = 1'-0"

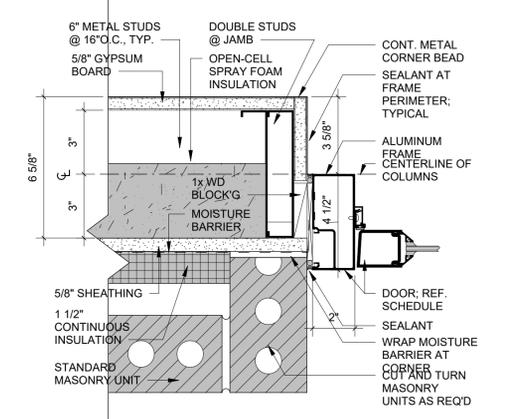

**6 JAMB DETAIL**  
SCALE: 3" = 1'-0"

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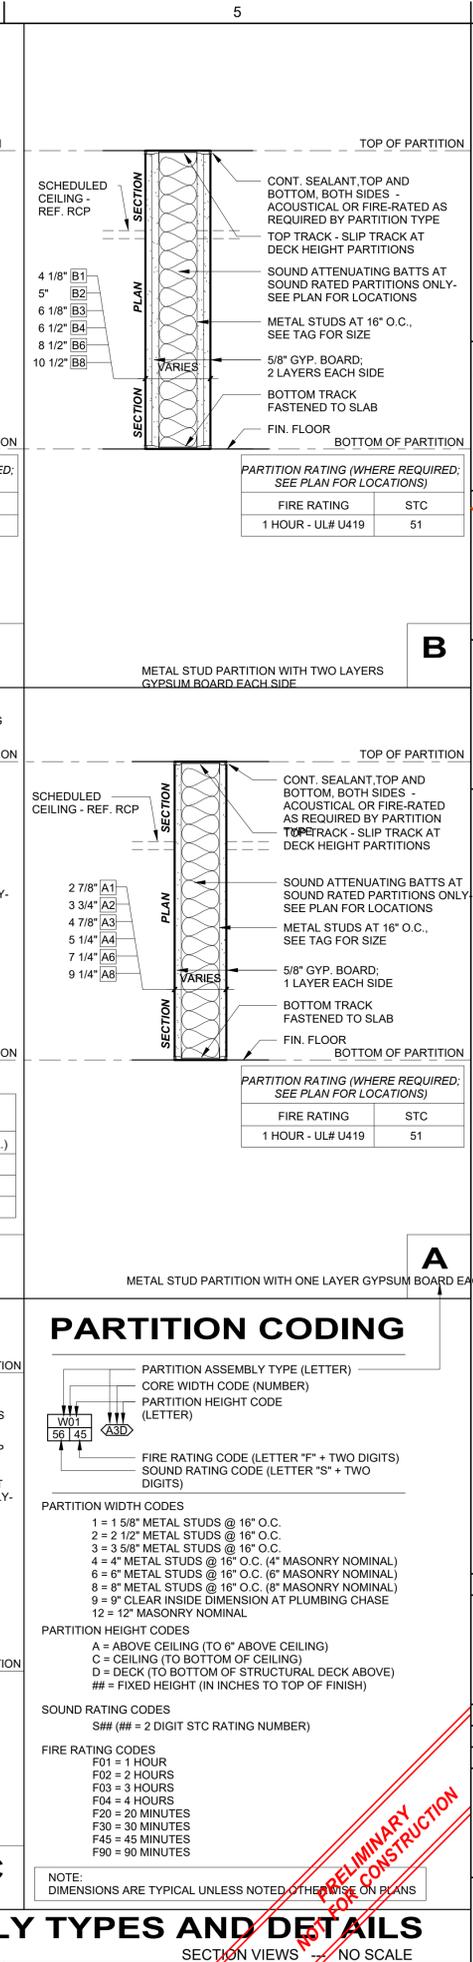
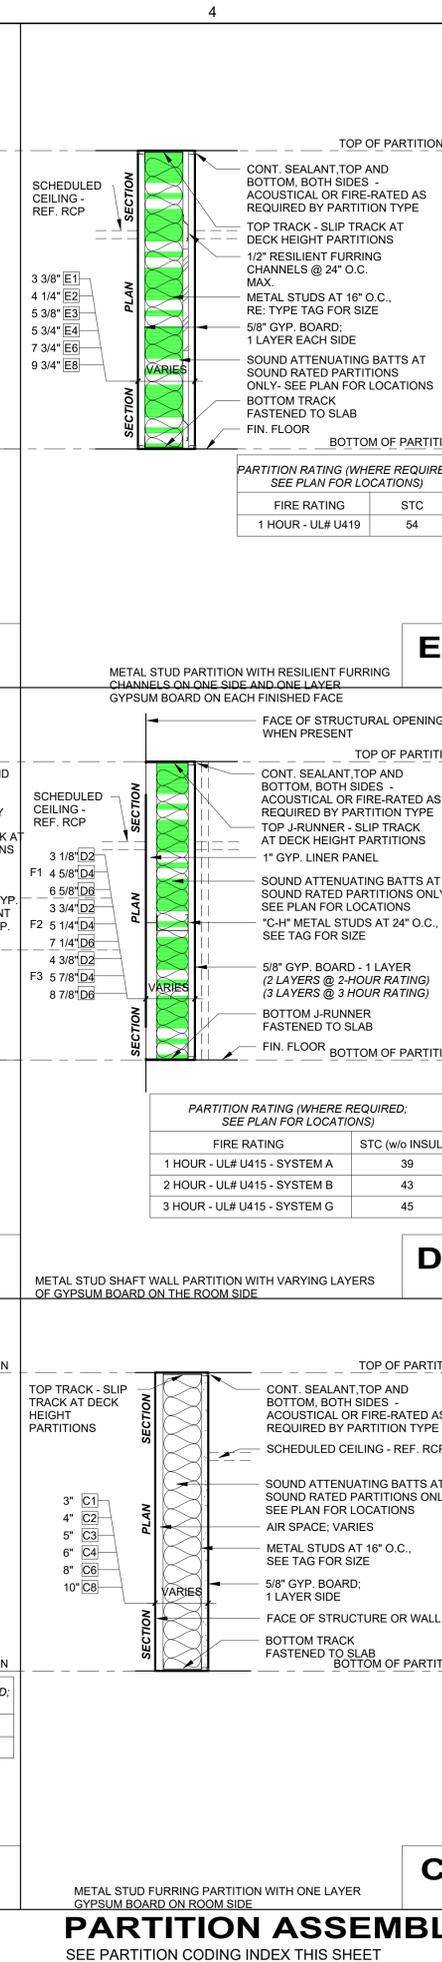
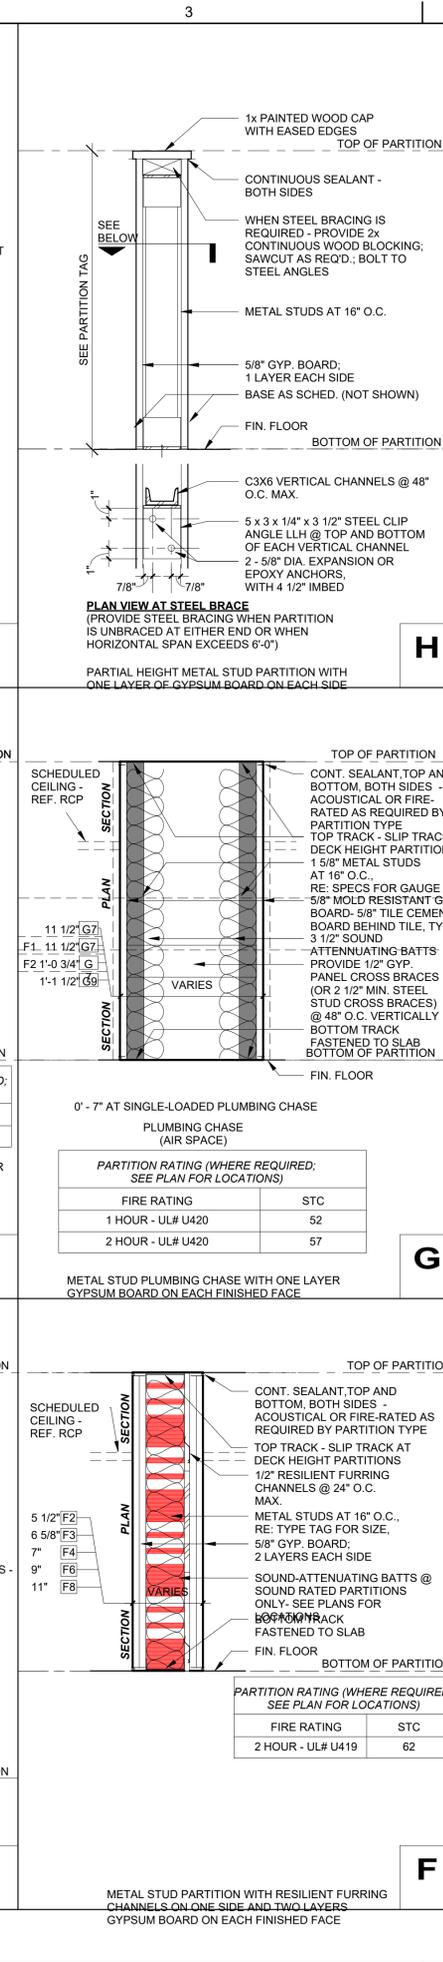
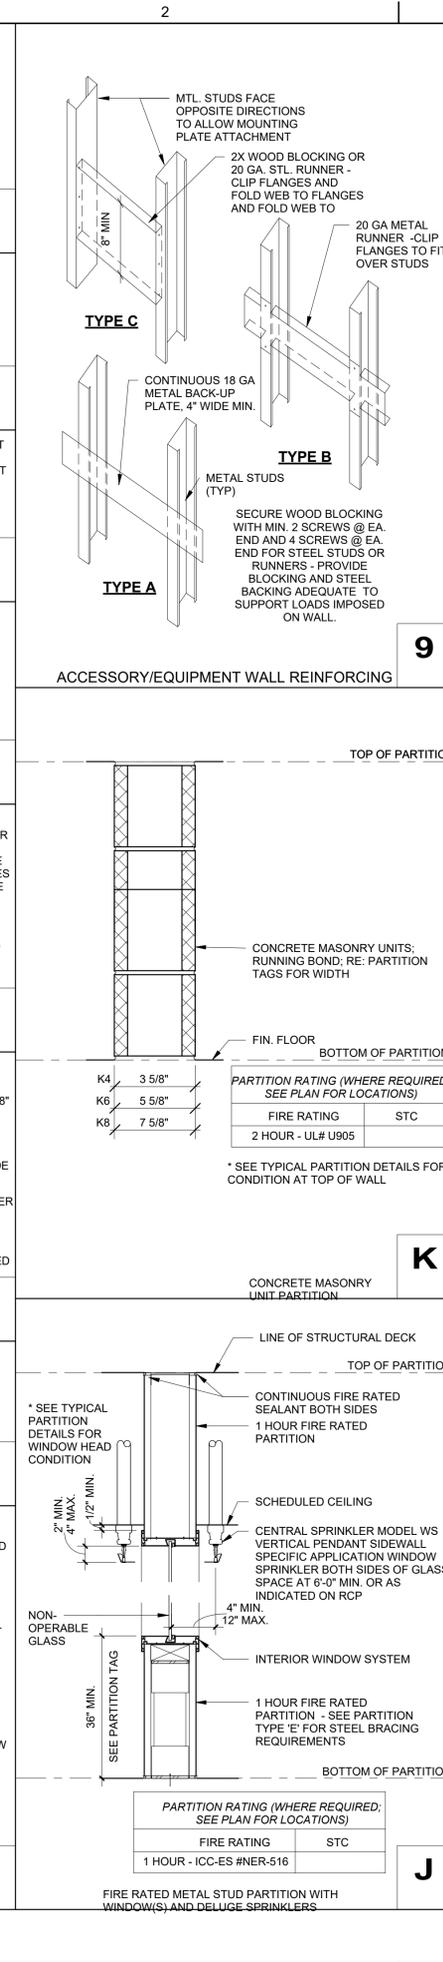
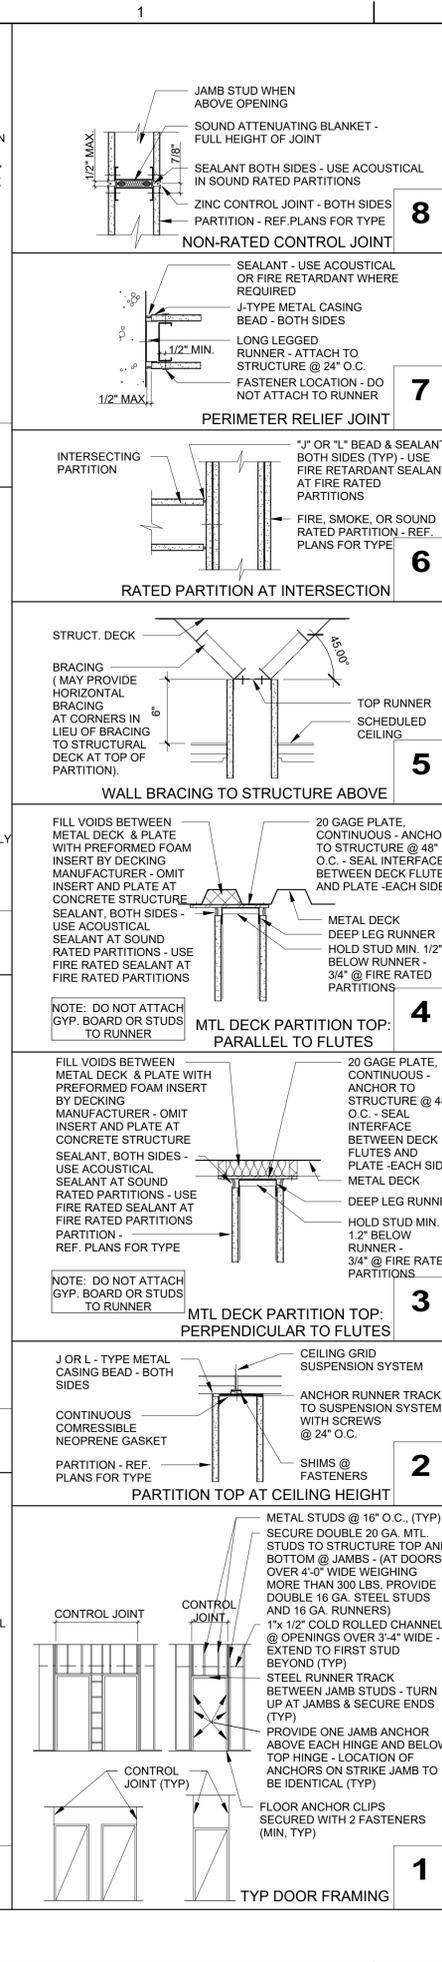
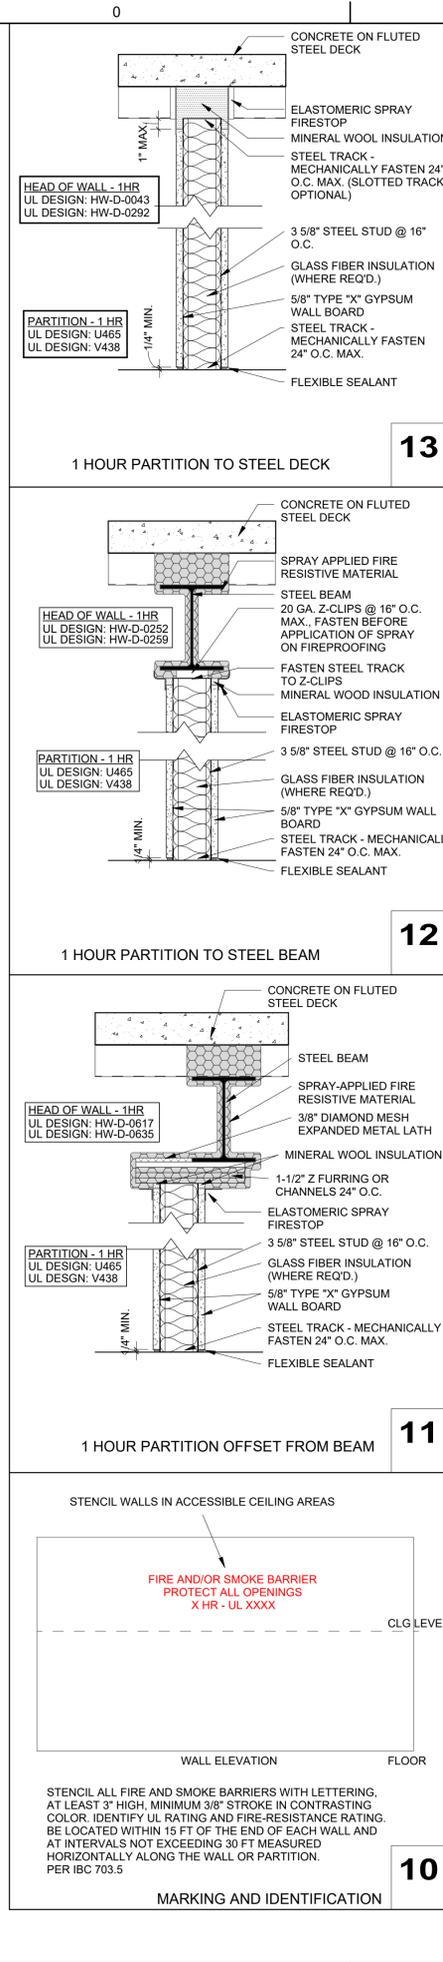
**A12.4**

DOOR AND WINDOW DETAILS

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Autodesk Docs: /2505 St. Nicholas Orthodox Church/2505 St. Nicholas\_R24.rvt 12/4/2025 11:44:56 AM



**PARTITION CODING**

PARTITION ASSEMBLY TYPE (LETTER)  
 CORE WIDTH CODE (NUMBER)  
 PARTITION HEIGHT CODE (LETTER)  
 FIRE RATING CODE (LETTER "F" + TWO DIGITS)  
 SOUND RATING CODE (LETTER "S" + TWO DIGITS)

**PARTITION WIDTH CODES**  
 1 = 1 5/8" METAL STUDS @ 16" O.C.  
 2 = 2 1/2" METAL STUDS @ 16" O.C.  
 3 = 3 5/8" METAL STUDS @ 16" O.C.  
 4 = 4" METAL STUDS @ 16" O.C. (4" MASONRY NOMINAL)  
 6 = 6" METAL STUDS @ 16" O.C. (6" MASONRY NOMINAL)  
 8 = 8" METAL STUDS @ 16" O.C. (8" MASONRY NOMINAL)  
 9 = 9" CLEAR INSIDE DIMENSION AT PLUMBING CHASE  
 12 = 12" MASONRY NOMINAL

**PARTITION HEIGHT CODES**  
 A = ABOVE CEILING (TO 6" ABOVE CEILING)  
 C = CEILING (TO BOTTOM OF CEILING)  
 D = DECK (TO BOTTOM OF STRUCTURAL DECK ABOVE)  
 # = FIXED HEIGHT (IN INCHES TO TOP OF FINISH)

**SOUND RATING CODES**  
 S## (## = 2 DIGIT STC RATING NUMBER)

**FIRE RATING CODES**  
 F01 = 1 HOUR  
 F02 = 2 HOURS  
 F03 = 3 HOURS  
 F04 = 4 HOURS  
 F20 = 20 MINUTES  
 F30 = 30 MINUTES  
 F45 = 45 MINUTES  
 F90 = 90 MINUTES

NOTE: DIMENSIONS ARE TYPICAL UNLESS NOTED OTHERWISE ON PLANS

**SOMDAL ASSOCIATES**  
 ARCHITECTURE + INTERIOR DESIGN  
 533 TEXAS STREET, SUITE 1900 SHREVEPORT, LA 71101

**NOT FOR CONSTRUCTION**

**ST. NICHOLAS ORTHODOX CHURCH**  
 9100 Youree Dr., Shreveport, LA 71115

Date: 10/31/2025  
 REVISION DATE

Drawn by: LCM/EW  
 Checked by: Checker  
 Project #: 2505  
 Sheet: **A12.5**

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PARTITION TYPES

**PARTITION ASSEMBLY TYPES AND DETAILS**  
 SEE PARTITION CODING INDEX THIS SHEET

ROOM FINISH SCHEDULE										
ROOM NO.	ROOM NAME	FLOOR			WALL				CEILING	Comments
		FLOOR	BASE MTL	North Wall Finish	South Wall Finish	East Wall Finish	West Wall Finish			
100	Room									
101	Room									
102	CLASSROOM									
103	CLASSROOM									
104	MEP									
105	AUDITORIUM									
106	CLOSET									
107	KITCHEN									
108	WOMENS RESTROOM									
109	MENS RESTROOM									
110	CLASSROOM									
111	CLASSROOM									
112	CLOSET									
113	OFFICE									
114	ENTRY									
115	ARCADE									
116	FOYER									
117	WOMENS RESTROOM									
118	MENS RESTROOM									
119	MEP									
120	NAVE									
121	CRY ROOM									
122	STAGE									
123	FOYER									
124	SANCTUARY									
125	SACRISTY									
126	VESTMENT ROOM									
127	CLOSET									
128	NARTHEX									
129	BAPTISMAL FONT									
130	CLOSET									
131	BOOKSTORE									
132	RESTROOM									
133	ENTRY									
136	SOUTH TRANSEPT									
137	NORTH TRANSEPT									
201	Room									
202	OPEN TO BELOW									
203	Room									
204	VESTIBULE									
205	Room									

### FINISH MATERIAL LEGEND:

LEGEND:

APC	ACOUSTICAL PANEL CEILING	PLM	POLYMER FLOORING
CC	CUBICAL CURTAIN	PT	PAINT
CG	CORNER GUARD	RB	RESILIENT BASE
CPT	CARPET	RF	RUBBER FLOORING
CR	CHAIR RAIL	SC	SEALED CONCRETE
CT	CERAMIC TILE	SF	SPORTS FLOORING
CTB	CERAMIC TILE BASE	SS	SOLID SURFACE
DC	DECORATIVE GLASS	SW	SHEET WALL COVERING
EPT	EPOXY PAINT	VCT	VINYL COMPOSITION TILE
EPGB	EPOXY PAINTED GYPSUM BOARD	VPL	VINYL PLANK
FRP	FRP WALL PROTECTION	WC	WALL COVERING
HR	HANDRAIL	WCT	CERAMIC WALL TILE
ICB	INTEGRAL COVE BASE	WD	WOOD
PGB	PAINTED GYPSUM BOARD	WSV	WELDED SHEET VINYL
PL	PLASTIC LAMINATE	WT	WINDOW TREATMENT

#### FLOORING:

CPT1	-	A
CPT2	-	BB
CT1	-	AA
CT2	-	BB
PM1	-	AA
PM2	-	BB
SC1	-	AA
SC2	-	BB
SV1	-	AA
SV2	-	BB
WSV1	-	AA
WSV2	-	BB

#### BASE:

CB1	-	AA
CB2	-	BB
CPB1	-	AA
CPB2	-	BB
CTB1	-	PORCELAIN WOOD-LOOK TILE PLANK 3 X12 BULLNOSE (SUPPLIED BY INTERIOR EXPRESSIONS, WITH EPOXY GROUT)
CTB2	-	BB
RB1	-	AA
RB2	-	BB
RB3	-	CC

#### WALLS:

WCT1	-	AA
WCT2	-	BB
WCB1	-	AA
WC1	-	AA
WC2	-	BB
EPT1	-	AA
EPT2	-	BB
EPT3	-	CC
PT1	-	AA
PT2	-	BB
PT3	-	CC
PT4	-	DD
PT5	-	EE
PT6	-	FF
PT7	-	GG
APC1	-	AA
APC2	-	BB
PGB1	-	AA
EPGB1	-	AA

#### WALL PROTECTION:

CG	-	AA
HR	-	AA
BG	-	AA
SW	-	AA

#### PLASTIC LAMINATE:

PL1	-	AA
PL2	-	BB
PL3	-	CC

#### SOLID SURFACING MATERIAL:

SS1	-	AA
SS2	-	BB
SS3	-	CC

#### WINDOW TREATMENT:

WT	-	AA
----	---	----


CUBICLE CURTAIN: (OWNER FURNISHED, OWNER INSTALLED OR CONTRACTOR FURNISHED CONTRACTOR INSTALLED)

CC1	-	AA
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### GENERAL INTERIOR DESIGN NOTES:

- ALL HOLLOW METAL DOOR FRAMES SHALL BE PAINTED PT... UNLESS OTHERWISE NOTED.
- CAULK ALL DOOR FRAMES WHERE THEY MEET HARD SURFACE FLOORING. CAULK TO COLOR OF DOOR FRAMES. PROVIDE TRANSITION STRIP AT ALL FLOORING MATERIAL JUNCTURES. REFER TO ID1.0 FOR DETAILS. CENTER OF TRANSITION STRIP TO BE LOCATED UNDER CENTER OF DOOR.
- REFER TO DETAIL \_/A17\_ FOR ELEVATOR CAB FLOOR PATTERN FINISH.
- REFER TO FLOOR FINISH PLANS FOR ACCENT PAINT LOCATIONS.
- INSTALL WALL COVERING BORDERS ON WALL AT CEILING LINE, UNLESS OTHERWISE NOTED.
- ALL WINDOW SILLS TO BE... UNLESS OTHERWISE NOTED.
- WHERE INTEGRAL COVE BASE IS USED WITH A FLOOR PATTERN, CONTINUE THE PATTERN UP THROUGH THE COVE BASE.
- INSTALL RANDOM VCT FLOOR PATTERNS FOLLOWING LAYOUT INDICATED ON DRAWINGS.
- ALL FLOORING MATERIALS TO EXTEND TO WALL UNDER OPEN COUNTERS.
- INDICATES WALL PROTECTION LOCATION.
- PAINT FACE OF BULKHEADS TO MATCH ADJACENT WALL COLOR, UNLESS NOTED OTHERWISE.
- PROVIDE BLOCKING AS NEEDED FOR ALL WINDOW TREATMENTS.
- INSTALL HANDRAIL AT 34" AFF TO CENTER OF RAIL.
- INSTALL BUMPER GUARD AT 34" AFF TO CENTER OF GUARD.
- INSTALL CORNER GUARDS 5" AFF TO HEIGHT AS INDICATED BY PRODUCT.


### WALL PROTECTION LEGEND

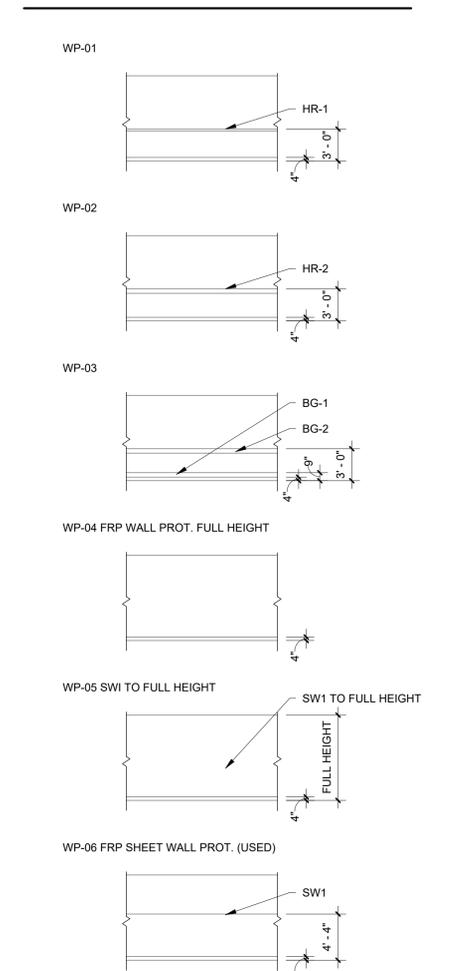

### FLOOR PATTERN LEGEND:

LUXURY VINYL TILE FLOOR LEGEND	LVT 1
	LVT 2
	LVT 3
CERAMIC TILE FLOOR LEGEND	T 1
	T 2
	T 3

### FLOORING TRANSITIONS

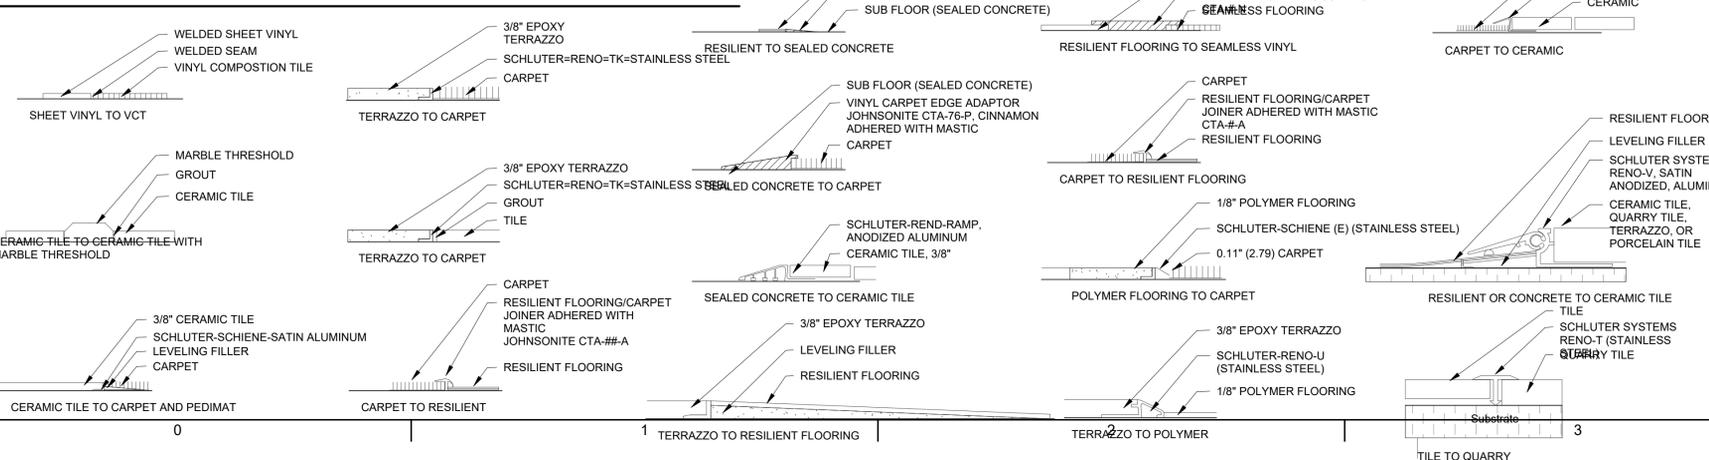

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**NOT FOR CONSTRUCTION**

NEW TEMPLE BUILDING FOR  
**ST. NICHOLAS ORTHODOX CHURCH**  
9100 Youree Dr, Shreveport, LA 71115

Date: 10/31/2025  
REVISION DATE

Drawn by: EBW  
Checked by: Checker  
Project #: 2505  
Sheet:

**ID1.1**

INTERIOR FINISH PLAN

**PRELIMINARY NOT FOR CONSTRUCTION**

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